GENERAL CONSTRUCTION NOTES

- 1. ANY PLANT MATERIAL THAT MUST BE REMOVED DUE TO CONSTRUCTION MUST BE APPROVED BY LANDSCAPE ARCHITECT. NOTIFY OWNER AND LANDSCAPE ARCHITECT AT LEAST 48 HOURS PRIOR TO REMOVAL AND/OR RELOCATION OF ALL PLANTS.
- 2. IF ANY EXISTING PLANT MATERIAL THAT IS TO REMAIN IS DAMAGED BY CONTRACTOR, THE CONTRACTOR SHALL REPLACE THE DAMAGED PLANT WITH NEW MATERIAL OF THE SAME SIZE AND VARIETY AT CONTRACTOR'S EXPENSE AND AT NO COST TO THE OWNER.
- 3. DO NOT DISTURB, COMPACT, OR ADD SOIL WITHIN DRIPLINE OF TREES OR SHRUBS TO REMAIN WITHOUT APPROVAL AND SUPERVISION OF THE LANDSCAPE ARCHITECT.

GENERAL PROJECT NOTES

THE DRAWINGS, SPECIFICATIONS, AND ADDENDA DESCRIBING WORK FOR LANDSCAPE, HARDSCAPE, AND IRRIGATION PORTIONS OF THE PROJECT SHALL BE REFERRED TO AS THE LANDSCAPE CONSTRUCTION

- 1. COMPLIANCES A. WORK UNDER THESE LANDSCAPE CONSTRUCTION DOCUMENTS SHALL BE IN ACCORDANCE WITH THE LOCAL JURISDICTION UNLESS SPECIFIED OTHERWISE IN THE LANDSCAPE CONSTRUCTION DOCUMENTS. THE CONTRACTOR SHALL BE FAMILIAR WITH THESE STANDARD SPECIFICATIONS, DETAILS, AND SUPPLEMENTS PRIOR TO BIDDING THE WORK COVERED BY THESE PLANS AND SPECIFICATIONS.
- B. WORK UNDER THESE LANDSCAPE CONSTRUCTION DOCUMENTS SHALL CONFORM TO ALL APPLICABLE CODES AND ORDINANCES (FEDERAL, STATE, LOCAL, AND HEALTH DEPARTMENTS) C. EXISTING TREES TO BE SAVED SHALL BE PROTECTED BY TREE PROTECTIVE FENCING BEFORE CONSTRUCTION BEGINS. NO EQUIPMENT OR MATERIALS SHALL BE STORED, OPERATED OR MAINTAINED WITHIN THE FENCED AREA. FENCES SHALL BE ON THE DRIPLINE AND COMPLETELY SURROUND THE TREE OR CLUSTERS OF TREES. NO CLEANING OF EQUIPMENT TRUCKS WILL BE ALLOWED IN THESE AREAS.
- d. ALL AREAS OF NATIVE VEGETATION BEYOND THE LIMITS OF CONSTRUCTION SHALL BE LEFT UNDISTURBED.
- 2. CONTRACTOR RESPONSIBILITIES A. IT IS THE CONTRACTOR'S RESPONSIBILITY TO INSPECT THE JOB SITE TO BECOME FAMILIAR WITH ALL EXISTING CONDITIONS THAT COULD AFFECT THE INSTALLATION OF ANY WORK SET FORTH IN b. THE CONTRACTOR IS SOLELY RESPONSIBLE FOR OBTAINING AND COMPLYING WITH ANY PERMITS
- REQUIRED BY THE GOVERNING JURISDICTION TO COMPLETE ANY WORK COVERED BY THE LANDSCAPE CONSTRUCTION DOCUMENTS. C. THE CONTRACTOR SHALL REVIEW THIS PROJECT AND PROPOSED CONSTRUCTION SEQUENCE MILESTONE DATES WITH THE LANDSCAPE ARCHITECT PRIOR TO STARTING ANY WORK. D. CONTRACTOR SHALL SCHEDULE A PRE-CONSTRUCTION CONFERENCE WITH LANDSCAPE
- ARCHITECT PRIOR TO COMMENCING WORK. E. THE CONTRACTOR IS RESPONSIBLE FOR THE CONSTRUCTION MEANS, METHODS, COORDINATION. & SEQUENCING OF THE WORK.
- F. THE CONTRACTOR IS RESPONSIBLE FOR DAMAGE TO EXISTING WALKS, WALLS, DRIVES, CURBS, UTILITIES, ETC. DAMAGED ELEMENTS SHALL BE REPLACED OR REPAIRED AT CONTRACTOR'S EXPENSE. G. THE CONTRACTOR SHALL COORDINATE HIS WORK WITH THAT OF OTHER TRADES ON THE SITE AS
- NECESSARY TO ENSURE ORDERLY AND EFFICIENT COMPLETION OF ALL WORK. H. CONSULT PROJECT SPECIFICATIONS FOR WARRANTY REQUIREMENTS. 3. QUESTIONS, DISCREPANCIES, MODIFICATIONS
- A. SHOULD THE CONTRACTOR HAVE ANY QUESTIONS REGARDING THE LANDSCAPE CONSTRUCTION DOCUMENTS, THE LANDSCAPE ARCHITECT SHALL BE CONTACTED FOR CLARIFICATION BEFORE
- B. ANY DISCREPANCIES BETWEEN THE PLANS AND ANY SITE CONDITIONS SHALL BE REPORTED IN WRITING IMMEDIATELY TO LANDSCAPE ARCHITECT. C. ANY DISCREPANCIES IN THE DRAWINGS SHALL BE REPORTED IN WRITING IMMEDIATELY TO
- LANDSCAPE ARCHITECT PRIOR TO THE START OF WORK. D. NO DESIGN MODIFICATIONS SHALL BE MADE WITHOUT THE WRITTEN APPROVAL OF THE
- LANDSCAPE ARCHITECT. 4. LOCATE UNDERGROUND UTILITIES PRIOR TO STARTING ANY CONSTRUCTION AND PROTECT FROM DAMAGE DURING CONSTRUCTION. THE CONTRACTOR SHALL CALL THE UNIVERSITY FACILITIES DEPARTMENT OR TEXAS ONE CALL NOTIFICATION SYSTEM (1-800-245-4545) PRIOR TO ANY EXCAVATION. EXISTING UNDERGROUND SERVICES SHALL NOT BE DISTURBED OR REMOVED UNLESS SPECIFICALLY NOTED OTHERWISE ON DRAWINGS OR WITHOUT THE WRITTEN APPROVAL OF LANDSCAPE ARCHITECT THE CONTRACTOR IS RESPONSIBLE FOR ANY DAMAGE TO UTILITIES AND/OR FACILITIES CAUSED
- DURING THE CONSTRUCTION OPERATIONS. 5. ANY CONFLICTS OR ADJUSTMENTS IN LAYOUT INFORMATION SHALL BE GRAPHICALLY PRESENTED TO THE LANDSCAPE ARCHITECT FOR APPROVAL PRIOR TO COMMENCEMENT OF WORK.
- 6. THE EXISTING QUANTITIES AND EXISTING SITE CONDITIONS SHOWN ON THESE PLANS ARE FOR INFORMATIONAL PURPOSES ONLY. THE CONTRACTOR SHALL VERIFY THE ACTUAL QUANTITIES AND SITE CONDITIONS PRIOR TO BIDDING THE WORK COVERED BY THESE PLANS AND SPECIFICATIONS. 7. FINE GRADING TO ESTABLISH UNIFORM SMOOTH GRADE IS INCLUDED IN THIS PROJECT.
- 8. ALL GENERAL SITE GRADING TO BE WITHIN +/- 0.10 FOOT, INCLUDING ALL BERMS, SWALES, AND RETENTION AREAS WILL BE CONSTRUCTED AS PER THE GRADING AND DRAINAGE PLANS. LANDSCAPE AREAS SHALL NOT EXCEED 4:1 MAXIMUM SLOPE (EXCEPT WHERE INDICATED ON GRADING PLANS) AND TURF AREAS SHALL NOT EXCEED 5:1 MAXIMUM SLOPE. THE LANDSCAPE AND IRRIGATION CONTRACTOR SHALL VERIFY AND ACCEPT THESE ROUGH GRADES PRIOR TO STARTING ANY LANDSCAPE AND IRRIGATION WORK. ALL DRAINAGE FLOWS SHALL BE PROTECTED AND MAINTAINED THROUGHOUT LANDSCAPE AND IRRIGATION CONSTRUCTION.
- 9. QUALITY: WORK & MATERIALS AS PART OF THIS PROJECT SHALL BE OF A GRADE & QUALITY CONSISTENT WITH THE INTENDED USE AS APPROVED BY THE LANDSCAPE ARCHITECT. WORK & MATERIALS NOT IN CONFORMANCE WITH THE LANDSCAPE CONSTRUCTION DOCUMENTS, OR THEIR INTENDED USE, ARE SUBJECT TO REMOVAL AND REPLACEMENT AT THE CONTRACTOR'S EXPENSE. 10. COMPLETE AND FUNCTIONING WORK: EQUIPMENT AND MATERIALS NOT SPECIFICALLY IDENTIFIED IN
- THE LANDSCAPE CONSTRUCTION DOCUMENTS --BUT THAT ARE REQUIRED FOR A COMPLETE AND FUNCTIONING INSTALLATION-- SHALL BE SUPPLIED AND INSTALLED BY THE CONTRACTOR AS PART OF THIS CONTRACT WORK WITHOUT ADDITIONAL COST TO THE OWNER. 11.CLEAN UP: SITE TO BE KEPT CLEAN AT ALL TIMES. PROVIDE TRASH BINS. AT THE COMPLETION OF THE
- CONSTRUCTION, THE PROJECT SHALL BE CLEANED OF ANY DEBRIS OR SPOIL RESULTING FROM THE CONSTRUCTION. SITE SHALL BE TURNED OVER TO THE OWNER IN BROOM OR RAKED CLEAN CONDITION. 12.FOR ALL STANDARD ENVIRONMENTAL NOTES, REFER TO CIVIL DRAWINGS

HARDSCAPE CONSTRUCTION NOTES

- 1. NOTIFY LANDSCAPE ARCHITECT A MINIMUM OF 48 HOURS PRIOR TO COMMENCEMENT OF CONCRETE OPERATIONS. ALLOW LANDSCAPE ARCHITECT TO OBSERVE EXCAVATIONS, FORMWORK, AND REINFORCING PRIOR TO CONCRETE PLACEMENT.
- 2. PROVIDE ELECTRICAL AND IRRIGATION SLEEVES UNDER PAVING AND THROUGH WALLS TO ALL PLANTING AREAS. NO EXCAVATION UNDER FOOTINGS SHALL BE PERMITTED. ALL SLEEVES TO RUN THROUGH THE STEM WALL BELOW GRADE. 3. CONTRACTOR TO LOCATE ANY EXISTING IRRIGATION SLEEVES THAT NEED TO BE REPLACED
- FOLLOWING DEMOLITION AND PROPOSE ANY NECESSARY NEW SLEEVE LOCATIONS FOR APPROVAL BY LANDSCAPE ARCHITECT. REF IRRIGATION DRAWINGS FOR NEW AND REPLACEMENT SLEEVING SIZING AND LOCATION REQUIREMENTS. 4. FOUNDATIONS FOR LANDSCAPE ELEMENTS: EXCAVATIONS SHALL BE NEAT TO LINES OF FOOTINGS. ALL
- LOOSE MATERIAL SHALL BE REMOVED FROM SURFACE TO RECEIVE CONCRETE. PLACE FOUNDATION CONCRETE ONLY ON CLEAN, FIRM, INSPECTED BEARING MATERIAL. FOOTINGS SHALL BEAR ON UNDISTURBED NATIVE SOIL OR ENGINEERED FILL. BEAR FOOTINGS AT DEPTHS INDICATED ON PLANS BUT AT DEPTHS NO SHALLOWER THAN 18" BELOW THE GRADE WITHIN 5 FEET OF THE FOUNDATION, UNLESS OTHERWISE NOTED ON THE STRUCTURAL PLANS.
- 5. VERIFY HEIGHTS, SLOPES, EDGE THICKNESS, AND TURNDOWNS BEFORE POURING FOOTINGS AND
- 6. CONCRETE FORMWORK FOR EXPOSED CONCRETE SHALL BE INSPECTED BY LANDSCAPE ARCHITECT AND APPROVED PRIOR TO CONCRETE POURS. CURVED FORMWORK SHALL BE CONTINUOUS THROUGHOUT THE CURVE, WITHOUT BREAKS OR FOLDS.
- 7. CONCRETE FLAT WORK SHALL BE INSTALLED WITH A CONSTANT SLOPE BETWEEN TWO SPOT ELEVATIONS. CHANGES IN SLOPE SHALL BE ACCOMPLISHED IN A GRADUAL MANNER. ALL HARDSCAPE SHALL SLOPE AWAY FROM BUILDINGS AT MINIMUM (2%) SLOPE [MAXIMUM 1:20 (5%) SLOPE], PER GEOTECH; AND MEET ALL ADA REQUIREMENTS WHERE REQUIRED.
- 8. CONTROL JOINTS IN PAVING SHALL BE SAW CUT (UNLESS SPECIFICALLY NOTED OTHERWISE), STRAIGHT AND TRUE. REFER TO THE DRAWINGS FOR PATTERNS.
- 9. CONCRETE JOINTING FOR WALLS AND FLAT WORK IS SCHEMATIC IN NATURE AND CONVEYS THE MINIMUM DESIGN INTENT. ADDITIONAL CONTRACTION, CONSTRUCTION AND EXPANSION JOINTS MAY BE REQUIRED. THE CONTRACTOR SHALL REVIEW ALL JOINTS SHOWN ON PLANS AND DESCRIBED IN THE SPECIFICATIONS PRIOR TO CONSTRUCTION. ALL REQUESTS FOR CHANGES TO JOINTING SHALL BE SUBMITTED TO THE LANDSCAPE ARCHITECT FOR REVIEW A MINIMUM OF FIVE (5) WORKING DAYS PRIOR TO CONSTRUCTION. IF ADDITIONAL JOINTS ARE NECESSARY TO ALLEVIATE CRACKING OR FACILITATE CONSTRUCTION, THEY SHALL BE PROVIDED AT NO ADDITIONAL COST. ADDITIONAL JOINTS REQUESTED BY THE OWNER, ENGINEER OR LANDSCAPE ARCHITECT FOR AESTHETIC PURPOSES SHALL BE CONSIDERED ADDITIONAL TO THE BASE CONTRACT.

LAYOUT NOTES

LOCATIONS OF ALL EXISTING BUILDINGS, HARDSCAPE ELEMENTS, AND TREES, AS WELL AS GRADES. THIS SURVEY DOES NOT REFLECT CHANGES TO GRADE AND DRAINAGE PATTERNS RESULTING FROM SUBSEQUENT SITE DEVELOPMENT. IN THE EVENT THAT LAYOUT BASED ON THIS SURVEY AND THE CAD FILES PROVIDED DOES NOT MATCH CONDITIONS IN THE FIELD, THE CONTRACTOR SHALL IMMEDIATELY NOTIFY THE LANDSCAPE ARCHITECT AND REQUEST FURTHER DIRECTION TO RECTIFY THE DISCREPANCY. THIS DIRECTIVE INCLUDES, BUT IS NOT LIMITED TO, CONSTRUCTION THAT WOULD IMPACT EXISTING TREES AND ALIGNMENTS WITH EXISTING ELEMENTS THAT ARE IN CONFLICT.

1. THE LANDSCAPE ARCHITECT HAS RELIED UPON THE SURVEY PROVIDED BY THE UNIVERSITY FOR

- 2. CONTRACTOR TO FIELD STAKE ALL HARDSCAPE LAYOUT FOR APPROVAL BY LANDSCAPE ARCHITECT 3. CONTRACTOR TO GIVE LANDSCAPE ARCHITECT 48 HOURS NOTICE PRIOR TO ALL SITE VISITS TO
- OBSERVE LAYOUT. 4. CONTRACTOR TO TAG, FOR APPROVAL BY LANDSCAPE ARCHITECT, ALL VEGETATION PROPOSED TO BE REMOVED TO MAKE WAY FOR NEW CONSTRUCTION.
- 5. CONTRACTOR TO FIELD STAKE PROPOSED LIMITS OF CONSTRUCTION FOR TREE AND NATURAL AREA PROTECTION FOR APPROVAL BY LANDSCAPE ARCHITECT. SEE DETAILS FOR TREE AND NATURAL AREA
- 6. CONTRACTOR TO FIELD STAKE CENTER LINE OF ALL PATHS, FOR APPROVAL BY LANDSCAPE ARCHITECT, PRIOR TO SETTING FORMS.
- 7. CURVES ON ALL PATHS TO HAVE SMOOTH RADII WITH NO SHARP TURNS OR. KINKS IN RADII OR.
- 8. NEW PATHS AND PAVING TO MATCH EXISTING GRADES WHERE TIED IN TO EXISTING SURFACES TO REMAIN. CONTRACTOR SHALL BE RESPONSIBLE TO ENSURE THAT NEW SURFACES SLOPE TO PROVIDE ADEQUATE DRAINAGE AND ALSO MEET ADA REQUIREMENTS FOR MAXIMUM SLOPE AND CROSS-SLOPE. CONTRACTOR SHALL BE RESPONSIBLE TO ENSURE THAT NEW WORK DOES NOT RESULT IN PONDING OR EROSION DUE TO CHANGES IN DRAINAGE PATTERNS. ROUTE DRAINAGE FLOWS AROUND OR UNDER NEW WORK AS REQUIRED. NOTIFY LANDSCAPE ARCHITECT OF CONDITIONS AND CIRCUMSTANCES IN THE FIELD WHERE DRAINAGE ISSUES MAY IMPACT LAYOUT.

ABBREVIATIONS

| ADJ ALT | adjacent alternate | NIC | not in contract |
|----------------|-------------------------------------|-----------|--------------------------------|
| APPROX ARCH | approximate architectural | NTS NO | not to scale number |
| B&B | balled and burlapped | OC | on center(s) |
| BTM | bottom | OCEW | on center each way |
| BC | bottom of curb | OPP | opposite |
| BS BLDG | bottom of steps building | OD | outside diameter |
| 0.4.1 | | PTD | paint(ed) |
| CAL | caliper | PVMT | pavement |
| CIP | cast-in-place | PERF | perforate(d) |
| CL | centerline | PL | plate |
| CLR | clear(ance) | POB | point of beginning |
| CONC | concrete | PL | property line |
| CMU | concrete masonry unit | DEE | reference |
| CJ | contraction joint | REF | |
| CF | cubic foot | REINF | reinforcing |
| CY | cubic yard | REV | revision(s), revised |
| DEMO | 1 1 1 1 10 | REQ | required |
| DEMO | demolish, demolition | ROW | right-of-way |
| DTL | detail | 0011 | |
| DIA | diameter | SCH | schedule |
| DBH | diameter breast height | SEC | section |
| DIM | dimension | SHT | sheet |
| DWG | drawing | SIM | similar |
| E147 | | SPEC | specification |
| EW | each way | SQ | square |
| ELEV | elevation | SST | stainless steel |
| EQ | equal | STL | steel |
| EQUIP | equipment | STRL | structural |
| EX(IST) | existing | TD | |
| EJ | expansion joint | TB | top of bridge / top of bench |
| EXT | exterior | TC | top of curb |
| FINI | fin: in b / n d) | TD | top of drain |
| FIN | finish(ed) finished floor elevation | TH | thick(ness) |
| FFE | | TP | top of paving |
| FG | finish grade | TS TV | top of steps |
| FL | flow line | TV | top of vault |
| FT | foot, feet | TW | top of wall |
| C 4 | | TYP | typical |
| GA GALV | gage, gauge | LION | |
| _ | galvanized | UON | unless otherwise noted |
| GC | general contract(or) | \ | :£ . |
| GB | grade break | VFY | verify |
| HD | boovy duty | VIF | verify in field vertical |
| HT | heavy duty height | VERT | vertical |
| HP | high point | WWF | welded wire fabric |
| TIF | nigh point | W | |
| INT | interior | | width, wide |
| INV | invert | W/ W/O | with without |
| IIV | IIIVert | WD | wood |
| LA | landscape architect | WWM | wood woven/welded wire mesh |
| L | length | VVVVIVI | woven/weided wire mesn |
| LOC | limit of contract | 0\/845 | 201.0 |
| LF | linear feet | SYMI | BOLS |
| LP | low point | @ | at |
| LI | low politi | ' | feet |
| МН | manhole | " | inches, seconds |
| MFR | manufacture(r) | o | degrees |
| MAX | maximum | Q. | centerline |
| MECH | mechanic(al) | ø | diameter |
| MIN | minimum | # | pound, number |
| MISC | miscellaneous | | • • |
| 141100 | moonanoodo | | |

BIDDER'S SCOPE

- 1. BID ALTERNATE NO. 1: MAPLE ENTRY PAVILION
- 2. BID ALTERNATE NO. 2: MAPLE ENTRY GRADING / BRIDGE CULVERT 3. ALL OTHER WORK TO BE INCLUDED AS BASE BID

UNIVERSITY OF TEXAS AT PERMIAN BASIN

SITE SECTIONS

OVERALL ENLARGEMENT KEY PLAN

PAVING ENLARGEMENTS

PAVING ENLARGEMENTS

PAVING ENLARGEMENTS

CAMPUS TRANSFORMATION: QUAD & MAPLE ENTRANCE RENOVATION

RFP No: 742-25-234-2

LANDSCAPE ARCHITECTURE SUBMITTAL 100% IFC CONSTRUCTION DOCUMENTS

GRADING PLAN - A

GRADING PLAN - B

GRADING PLAN - C

GRADING PLAN - D

GRADING PLAN - E

GRADING PLAN - F

GRADING PLAN - G

GRADING PLAN - H

GRADING PLAN - I

GRADING PLAN - J

L112 GRADING PLAN - K

L102

L104

L108

L109

L110 L111

| SHEET INDEX | | | | | | | | | | |
|-------------|--|-------|--------------------------------|-----------------|-----------------------------|---------------------|---|--------|---------------------------------------|--|
| | Sheet Title | L113 | GRADING PLAN - L | L416 | PAVING ENLARGEMENTS | S101 | GENERAL NOTES | ED204 | ELECTRICAL SITE DEMOLITION PLAN - C | |
| G000 | COVER SHEET | L150 | GRADING PLAN - M ENLARGEMENT | L500 | PAVING DETAILS | S201 | OVERALL HARDSCAPE PLAN | ED205 | ELECTRICAL SITE DEMOLITION PLAN - D | |
| G001 | ORIENTATION PLAN | L151 | GRADING PLAN - N ENLARGEMENT | L510 | STAIR & RAIL DETAILS | \$202 | QUAD FOUNDATION AND FRAMING PLAN | ED206 | ELECTRICAL SITE DEMOLITION PLAN - E | |
| G002 | PROJECT AREA IDENTIFICATION PLAN | L152 | GRADING PLAN - O ENLARGEMENT | L511 | GABION WALL DETAILS | \$203 | MAPLE ENTRY FOUNDATION AND FRAMING PLAN | ED207 | ELECTRICAL SITE DEMOLITION PLAN - F | |
| G003 | SALVAGED MATERIALS PLAN | L200A | MATERIAL SCHEDULE | L512 | WALL DETAILS | S301 | CONCRETE TYPICAL DETAILS | E201 | ELECTRICAL OVERALL SITE PLAN | |
| CE101 | EROSION CONTROL PLAN | L200B | MATERIAL SCHEDULE | L513 | WALL DETAILS | S302 | CONCRETE TYPICAL DETAILS | E202 | ELECTRICAL SITE PLAN - A | |
| CE501 | EROSION CONTROL DETAILS | L201 | OVERALL HARDSCAPE PLAN | L520 | STEEL BRIDGE DETAILS | S310 | CONCRETE DETAILS | E203 | ELECTRICAL SITE PLAN - B | |
| CD101A | DEMOLITION PLAN A | L202 | HARDSCAPE PLAN - A | L530 | FURNITURE DETAILS | S311 | CONCRETE DETAILS | E204 | ELECTRICAL SITE PLAN - C | |
| CD101B | DEMOLITION PLAN B | L203 | HARDSCAPE PLAN - B | L540 | WATER FEATURE DETAILS | ∫ ₁ S312 | CONCRETE DETAILS | E205 | ELECTRICAL SITE PLAN - D | |
| CP101 | CIVIL PAVING PLAN | L204 | HARDSCAPE PLAN - C | L541 | WATER FEATURE DETAILS | AS001 | GENERAL NOTES | E206 | ELECTRICAL SITE PLAN - E | |
| CS101 | OVERALL PLAN MAPLE AVE | L205 | HARDSCAPE PLAN - D | /1 L550 | DRAINAGE DETAILS | AS111 | FOUNDATION AND FRAMING PLANS - STAGE PAV. | E207 | ELECTRICAL SITE PLAN - F | |
| CS102 | ENLARGED VIEWS | L206 | HARDSCAPE PLAN - E | L600 | IRRIGATION NOTES AND LEGEND | AS121 | FOUNDATION AND FRAMING PLANS - BBQ PAV. | EL001 | LIGHTING COVER SHEET | |
| CS103 | ENLARGED VIEWS | L207 | HARDSCAPE PLAN - F | L601 | OVERALL PLAN | AS131 | FOUNDATION AND FRAMING PLANS - ENTRY PAV. | EL010 | LIGHTING SCHEDULES | |
| CS104 | ENLARGED VIEWS | L208 | HARDSCAPE PLAN - G | L602 | IRRIGATION PLAN - A | AS201 | FRAME ELEVATIONS | EL101 | OVERALL SITE LIGHTING PLAN | |
| CS105 | ROUNDABOUT ALIGNMENTS | L209 | HARDSCAPE PLAN - H | L603 | IRRIGATION PLAN - B | AS202 | FRAME ELEVATIONS | EL102 | SITE LIGHTING PLAN - A | |
| CS106 | ROUNDABOUT ALIGNMENTS | L210 | HARDSCAPE PLAN - I | L604 | IRRIGATION PLAN - C | AS203 | FRAME ELEVATIONS | EL103 | SITE LIGHTING PLAN - B | |
| CS107 | ROUNDABOUT PROFILES | L211 | HARDSCAPE PLAN - J | L605 | IRRIGATION PLAN - D | AS501 | FOUNDATION DETAILS | EL104 | SITE LIGHTING PLAN - C | |
| CS501 | MAPLE ENTRY PAVING DETAILS | L212 | HARDSCAPE PLAN - K | L606 | IRRIGATION PLAN - E | AS511 | FRAMING DETAILS | EL105 | SITE LIGHTING PLAN - D | |
| CS502 | QUAD PAVING DETAILS | L213 | HARDSCAPE PLAN - L | L607 | IRRIGATION PLAN - F | AS512 | FRAMING DETAILS | EL106 | SITE LIGHTING PLAN - E | |
| CG101 | OVERALL GRADING PLAN | L250 | HARDSCAPE PLAN - M ENLARGEMENT | L608 | IRRIGATION PLAN - G | A101 | ARCHITECTURAL SITE PLAN | EL107 | SITE LIGHTING PLAN - F | |
| CG102 | GRADING PLAN ENLARGED | L251 | HARDSCAPE PLAN - N ENLARGEMENT | L609 | IRRIGATION PLAN - H | A111 | STAGE PAVILION | EL200 | LIGHTING PLAN - PAVILIONS | |
| CG103 | GRADING PLAN ENLARGED | L252 | HARDSCAPE PLAN - O ENLARGEMENT | L610 | IRRIGATION PLAN - I | A112 | BBQ PAVILION | WF 0.1 | WATER FEATURE SITE PLAN | |
| CG104 | GRADING PLAN ENLARGED | L301 | OVERALL LAYOUT PLAN | L611 | IRRIGATION PLAN - J | A113 | ENTRY PAVILION | WF 0.2 | WATER FEATURE UTILITIES | |
| CG105 | GRADING PLAN ENLARGED | L302 | LAYOUT PLAN - A | L612 | IRRIGATION PLAN - K | A501 | PANEL SCHEDULE & DETAILS | WF 1.0 | FIONA FEATURE LAYOUT | |
| CG106 | GRADING ADD ALTERNATE #2 | L303 | LAYOUT PLAN - B | L613 | IRRIGATION PLAN - L | MP111 | MECHANICAL AND PLUMBING PLAN | WF 1.1 | FIONA FEATURE DETAILS | |
| CM101 | PAVEMENT MARKING AND SIGNAGE | L304A | LAYOUT PLAN - C | L614 | IRRIGATION DETAILS | E-001 | ELECTRICAL SYMBOLS, LEGENDS, & ABBR. | WF 1.2 | FIONA FEATURE PIPE ROUTING | |
| CM501 | PAVEMENT MARKING DETAILS AND SIGNAGE | L304B | LAYOUT PLAN - C | L615 | IRRIGATION DETAILS | E-100 | ELECTRICAL SITE PLAN | WF 2.0 | PRAIRIE GARDEN FEATURE LAYOUT & DTLS. | |
| CU101A | STORM DRAIN PLAN A | L305 | LAYOUT PLAN - D | L616 | IRRIGATION DETAILS | E-121 | POWER PLAN | WF 2.1 | PRAIRIE GARDEN FEATURE PIPE ROUTING | |
| CU101B | STORM DRAIN PLAN B | L306A | LAYOUT PLAN - E | L617 | IRRIGATION PUMP DETAILS | XS001 | SIGNAGE DESIGN | WF 3.0 | MESA FEATURE LAYOUT | |
| CU102 | UTILITY PLAN | L306B | LAYOUT PLAN - E | L618 | IRRIGATION PUMP DETAILS | XS002 | SIGNAGE DESIGN | WF 3.1 | MESA FEATURE PIPE ROUTING | |
| CU103 | FIRE PROTECTION PLAN | L307 | LAYOUT PLAN - F | L700 | PLANTING SCHEDULE & NOTES | XS003 | SIGNAGE DESIGN | WF 4.0 | PIPING & INSTRUMENT DIAGRAM | |
| CU501 | UTILITY DETAILS | L308 | LAYOUT PLAN - G | L701 | OVERALL PLANTING PLAN | XS004 | SIGNAGE DESIGN | WF 4.1 | ELECTRICAL ONE-LINE | |
| CU502 | UTILITY DETAILS | L309 | LAYOUT PLAN - H | L702 | PLANTING PLAN - A | XS005 | SIGNAGE DESIGN | WF 4.2 | BILL OF MATERIALS | |
| CU503 | DRAINAGE DETAILS | L310 | LAYOUT PLAN - I | L703 | PLANTING PLAN - B | XS006 | SIGNAGE DESIGN | WF 5.0 | GENERAL DETAILS | |
| CU504 | DRAINAGE DETAILS | L311 | LAYOUT PLAN - J | L704 | PLANTING PLAN - C | XS007 | SIGNAGE DESIGN | WF 5.1 | PUMP DETAILS | |
| CU505 | DRAINAGE DETAILS | L312 | LAYOUT PLAN - K | L705 | PLANTING PLAN - D | XS008 | SIGNAGE DESIGN | WF 5.2 | LED BUBBLER | |
| CU506 | DRAINAGE DETAILS | L313 | LAYOUT PLAN - L | L706 | PLANTING PLAN - E | XS009 | SIGNAGE DESIGN | WF 5.3 | FILTER CHLORINATOR VALVE BOX | |
| L000 | OVERALL TREE PROTECTION & REMOVAL PLAN | L350 | LAYOUT PLAN - M ENLARGEMENT | L707 | PLANTING PLAN - F | XS010 | SIGNAGE DESIGN | | | |
| L002 | TREE PROTECTION DETAILS | L351 | LAYOUT PLAN - N ENLARGEMENT | L708 | PLANTING PLAN - G | XS011 | SIGNAGE DESIGN | | | |
| L021 | SOILS PLAN | L352 | LAYOUT PLAN - O ENLARGEMENT | <u>√</u> 1 L709 | PLANTING PLAN - H | XS012 | SIGNAGE DESIGN | | | |
| L022 | SOIL PREP DETAILS | L400 | SITE SECTIONS | L710 | PLANTING PLAN - I | XS013 | SIGNAGE DESIGN | | | |
| L101 | OVERALL GRADING PLAN | L401 | SITE SECTIONS | L711 | PLANTING PLAN - J | XS014 | SIGNAGE DESIGN | | | |

PLANTING PLAN - K

PLANTING PLAN - L

PLANTING DETAILS

PLANTING PLAN - M ENLARGEMENT

PLANTING PLAN - N ENLARGEMENT

PLANTING PLAN - O ENLARGEMENT

XS015 SIGNAGE DESIGN

XS016 SIGNAGE DESIGN

ELECTRICAL LEGEND, NOTES, AND ABBRS.

ED201 ELECTRICAL OVERALL DEMOLITION PLAN

ED202 ELECTRICAL SITE DEMOLITION PLAN - A

ED203 ELECTRICAL SITE DEMOLITION PLAN - B



TEN EYCK LANDSCAPE ARCHITECTS

1224 EAST 12TH STREET, SUITE 323 AUSTIN, TEXAS 78702 512 813 9999 www.teneyckla.com



UTPB ODESSA CAMPUS TRANSFORMATION: MAPLE ENTRY & THE QUAD

3900 John Ben Shepperd Parkway Odessa, TX 79762

TEN EYCK LANDSCAPE ARCHITECTS, INC. 1224 EAST 12TH STREET, SUITE 323

AUSTIN. TX 78702 512 813 9999 P ARCHITECT OF RECORD

ABILENE, TX 7960 325 673 8178 P **DESIGN ARCHITECT** LAKE FLATO ARCHITECTS

SAN ANTONIO, TX 78205 210 227 3335 P CIVIL ENGINEER 1700 WEST WALL STREET, SUITE 100

432 697 1447 P MEP ENGINEER 1701 DIRECTORS BLVD, SUITE 400

AUSTIN, TX 78744 512 445 2090 P HINES IRRIGATION CONSULTANTS 5049 EDWARDS RANCH ROAD, FLOOR 4

LIGHTING DESIGN

DENVER, CO 80202 720 644 5044 P 408 W EIGHTH STREET, SUITE 201

949 843 0713 P

ODESSA ARTS PO BOX 7195 STRUCTURAL ENGINEER (LANDSCAPE)

AUSTIN. TX 78756 512 472 2111 P WATER FEATURE 2550 PACIFIC AVENUE, SUITE 700

DALLAS, TX 75226

469 320 8771 P

3800 NORTH LAMAR BLVD SUITE 330




CONSTRUCTION DOCUMENTS

02/03/2025 100% IFC 1\ 02/28/2025 ADDENDUM NO2


DATE: 02/28/2025 DRAWN: TELA CHECKED: CTE

TELA PROJECT NO: 22013.00 DRAWING TITLE:

COVER SHEET

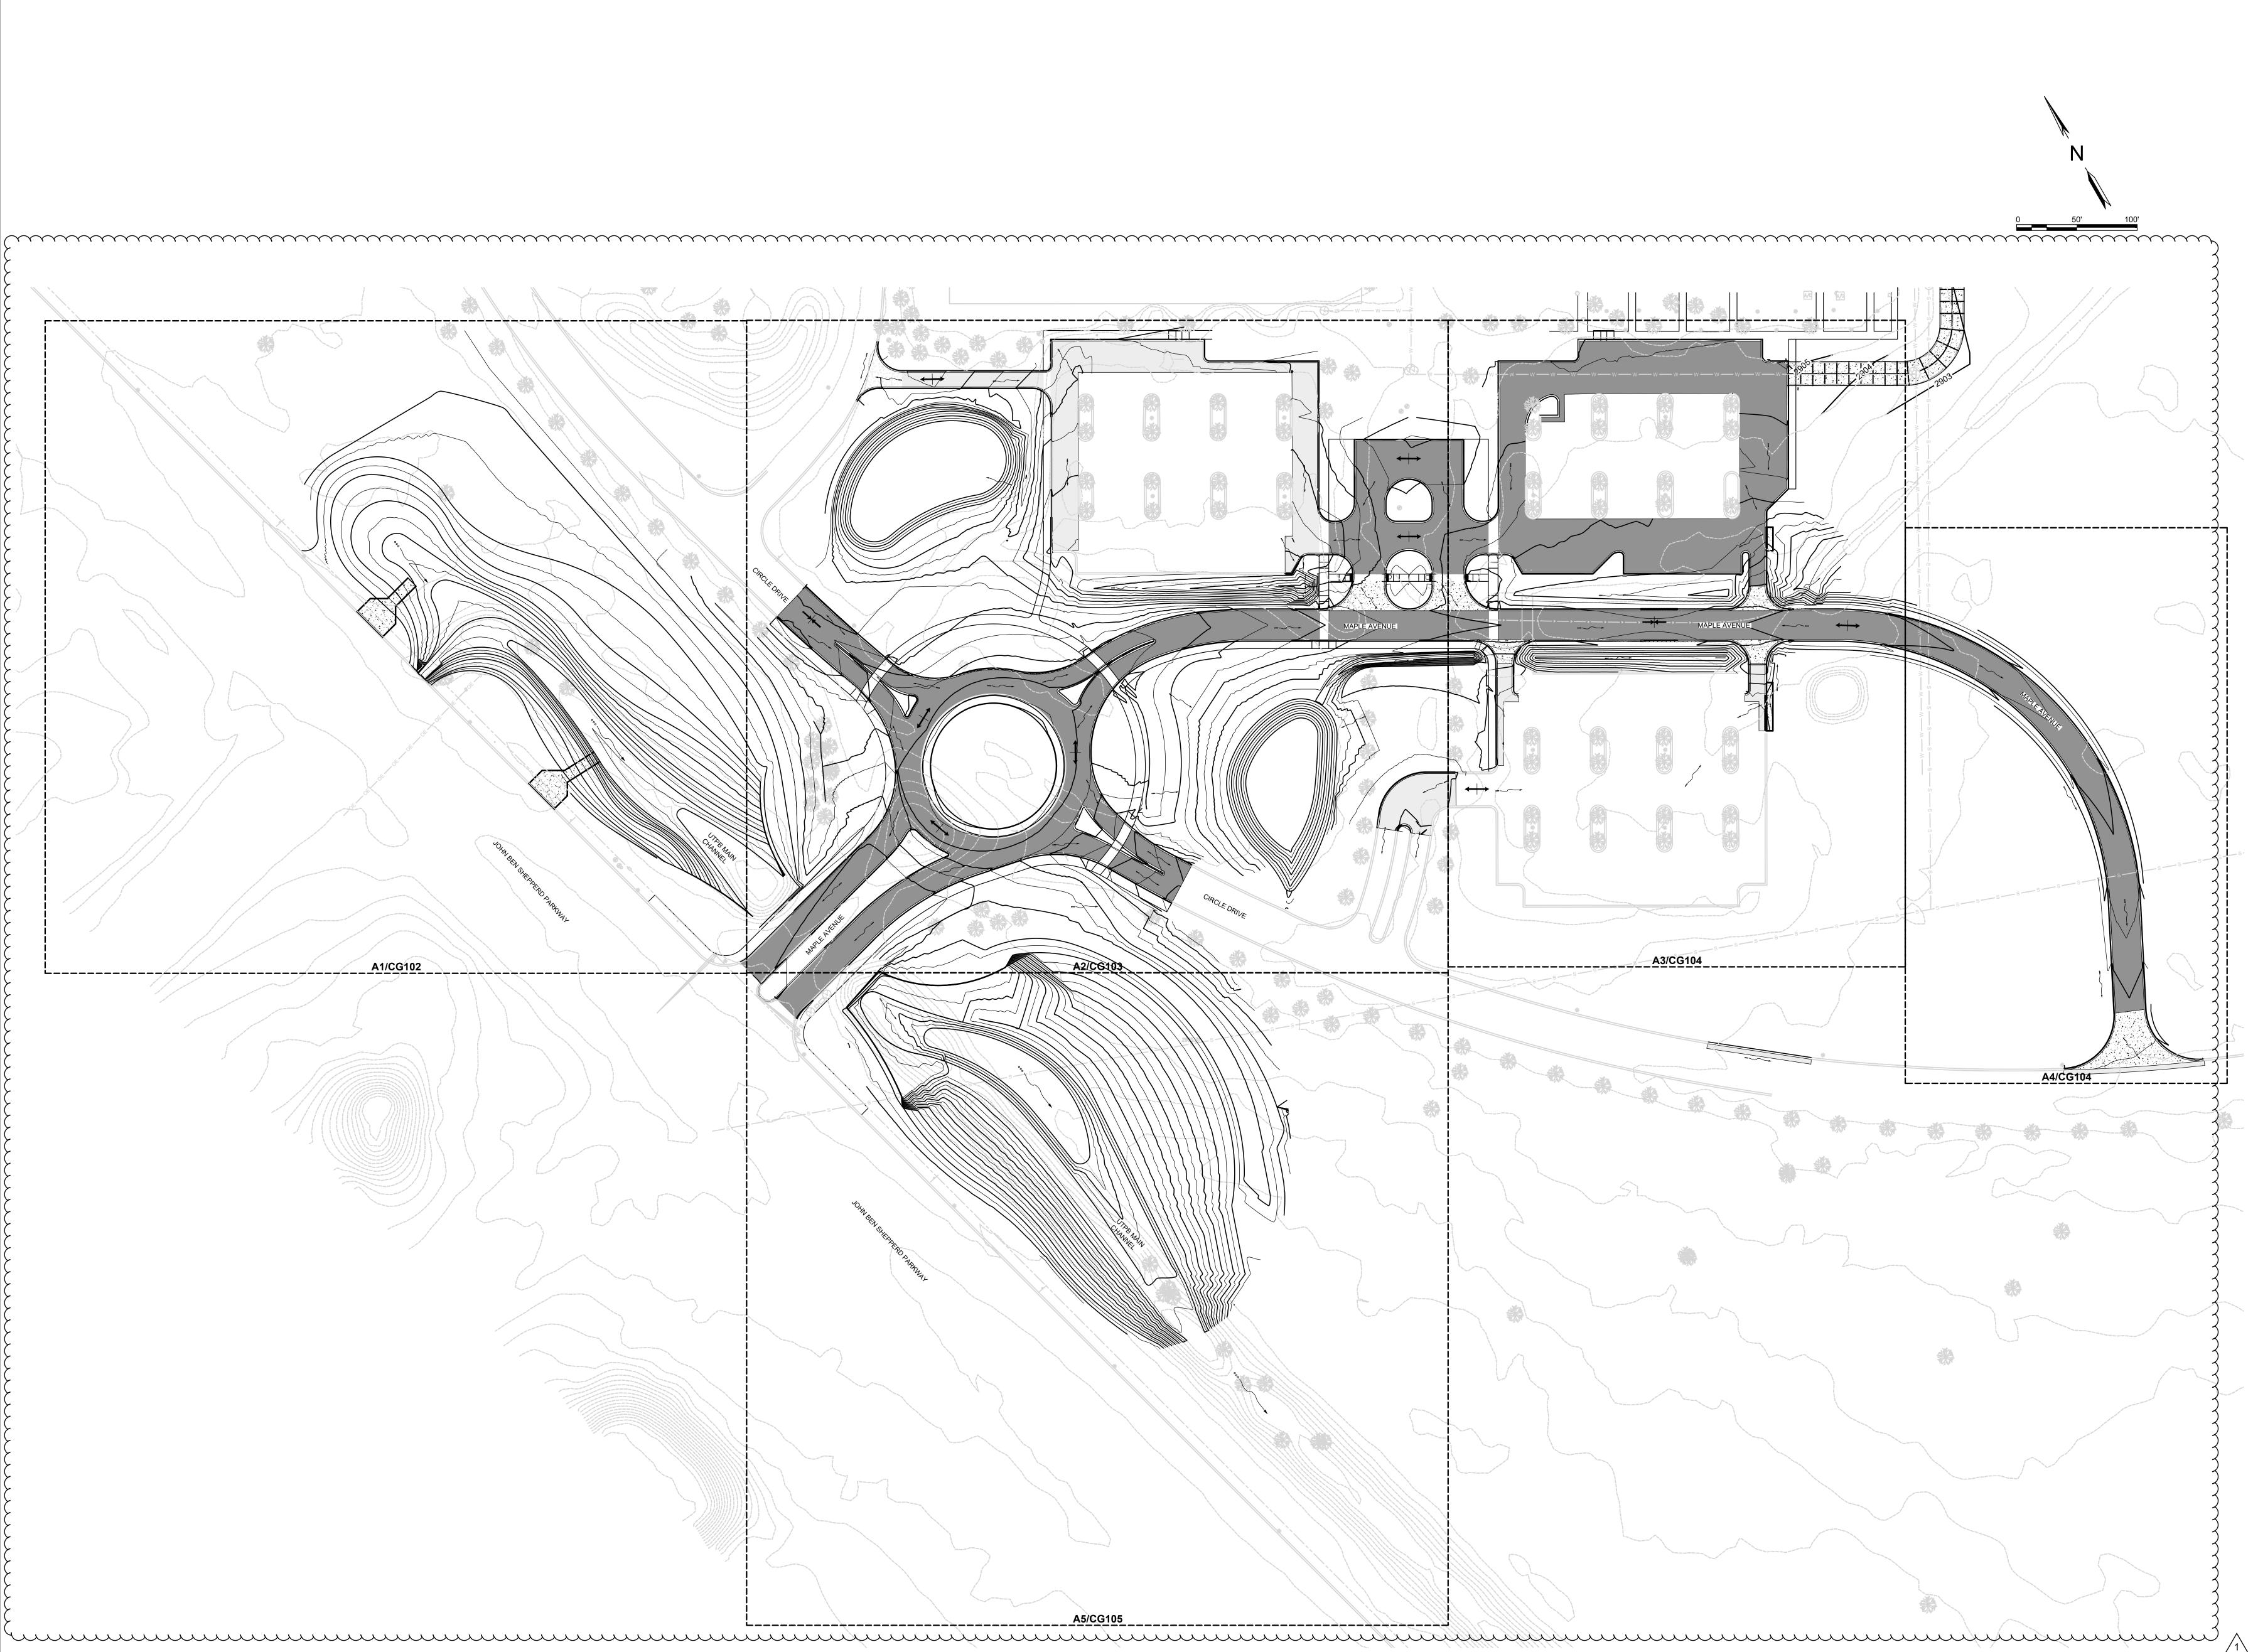

LANDSCAPE ARCHITECTS 1224 EAST 12TH STREET, SUITE 323 AUSTIN, TEXAS 78702 512 813 9999 www.teneyckla.com

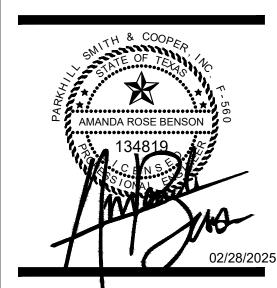

UTPB ODESSA **CAMPUS TRANSFORMATION:** MAPLE ENTRY & THE QUAD

3900 John Ben Shepperd Parkway Odessa, TX 79762

LANDSCAPE ARCHITECT

TEN EYCK LANDSCAPE ARCHITECTS, INC. 1224 EAST 12TH STREET, SUITE 323 AUSTIN, TX 78702 512 813 9999 P ARCHITECT OF RECORD

340 BEECH STREET ABILENE, TX 79601 325 673 8178 P **DESIGN ARCHITECT**

LAKE FLATO ARCHITECTS 311 3RD STREET SAN ANTONIO, TX 78205 210 227 3335 P **CIVIL ENGINEER**

1700 WEST WALL STREET, SUITE 100 MIDLAND, TX 79701 432 697 1447 P MEP ENGINEER

1701 DIRECTORS BLVD, SUITE 400 AUSTIN, TX 78744 512 445 2090 P

IRRIGATION
HINES IRRIGATION CONSULTANTS 5049 EDWARDS RANCH ROAD, FLOOR 4 FORT WORTH, TX 76109

970 233 3013 P LIGHTING DESIGN 1999 BROADWAY SUITE 2205 DENVER, CO 80202 720 644 5044 P


SIGNAGE RSM DESIGN 408 W EIGHTH STREET, SUITE 201 DALLAS, TX 75208

949 843 0713 P ARTIST

ODESSA ARTS PO BOX 7195 ODESSA, TX 79760 432 337 1492 P STRUCTURAL ENGINEER (LANDSCAPE)

ARCHITECTURAL ENGINEERS COLLABORATIVE 3800 NORTH LAMAR BLVD SUITE 330 AUSTIN, TX 78756 512 472 2111 P

WATER FEATURE 2550 PACIFIC AVENUE, SUITE 700 DALLAS, TX 75226 469 320 8771 P

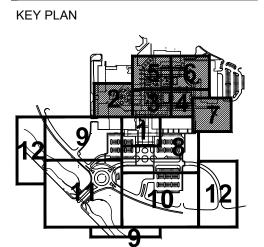

CONSTRUCTION DOCUMENTS

NO. DATE ISSUE 02/03/2025 100% IFC 1 02/28/2025 ADDENDUM NO2

DATE: 02/28/2025 DRAWN: PARKHILL

CHECKED: PARKHILL TELA PROJECT NO: 22013.00


DRAWING TITLE: Overall Grading Plan

CG101



TEN EYCK LANDSCAPE ARCHITECTS

1224 EAST 12TH STREET, SUITE 323 AUSTIN, TEXAS 78702 512 813 9999 www.teneyckla.com

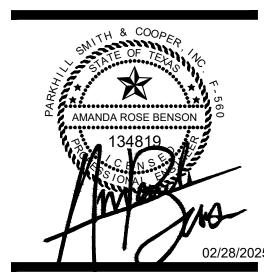

UTPB ODESSA **CAMPUS TRANSFORMATION:** MAPLE ENTRY & THE QUAD

3900 John Ben Shepperd Parkway Odessa, TX 79762

TEN EYCK LANDSCAPE ARCHITECTS, INC. 1224 EAST 12TH STREET, SUITE 323 AUSTIN, TX 78702 512 813 9999 P ARCHITECT OF RECORD

340 BEECH STREET ABILENE, TX 79601 325 673 8178 P **DESIGN ARCHITECT**

LAKE FLATO ARCHITECTS
311 3RD STREET
SAN ANTONIO, TX 78205
210 227 3335 P

CIVIL ENGINEER PARKHILL 1700 WEST WALL STREET, SUITE 100 MIDLAND, TX 79701 432 697 1447 P

MEP ENGINEER 1701 DIRECTORS BLVD, SUITE 400 AUSTIN, TX 78744 512 445 2090 P

IRRIGATION
HINES IRRIGATION CONSULTANTS
5049 EDWARDS RANCH ROAD, FLOOR 4
FORT WORTH, TX 76109

970 233 3013 P LIGHTING DESIGN 1999 BROADWAY SUITE 2205 DENVER, CO 80202 720 644 5044 P

408 W EIGHTH STREET, SUITE 201

DALLAS, TX 75208 949 843 0713 P ARTIST

ODESSA ARTS PO BOX 7195 ODESSA, TX 79760 432 337 1492 P STRUCTURAL ENGINEER (LANDSCAPE)

3800 NORTH LAMAR BLVD SUITE 330 AUSTIN, TX 78756 512 472 2111 P WATER FEATURE 2550 PACIFIC AVENUE, SUITE 700 DALLAS, TX 75226 469 320 8771 P

A. THE EXISTING CONTOURS AND SURFACE ELEVATIONS INDICATED ON THESE PLANS HAVE BEEN LOCATED FROM REFERENCE INFORMATION SUPPLIED BY OTHERS AND SURFACE LOCATIONS SHOWN. IT SHALL BE THE RESPONSIBILITY OF THE CONTRACTOR TO VERIFY, BOTH HORIZONTALLY AND VERTICALLY, THE LOCATIONS OF ALL EXISTING HARD SURFACE PRIOR TO CONSTRUCTION, AND TO NOTIFY THE

CONSTRUCTION DOCUMENTS


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DATE: 02/28/2025 DRAWN: PARKHILL

CHECKED: PARKHILL TELA PROJECT NO: 22013.00


DRAWING TITLE: Grading Enlarged Views

CG102

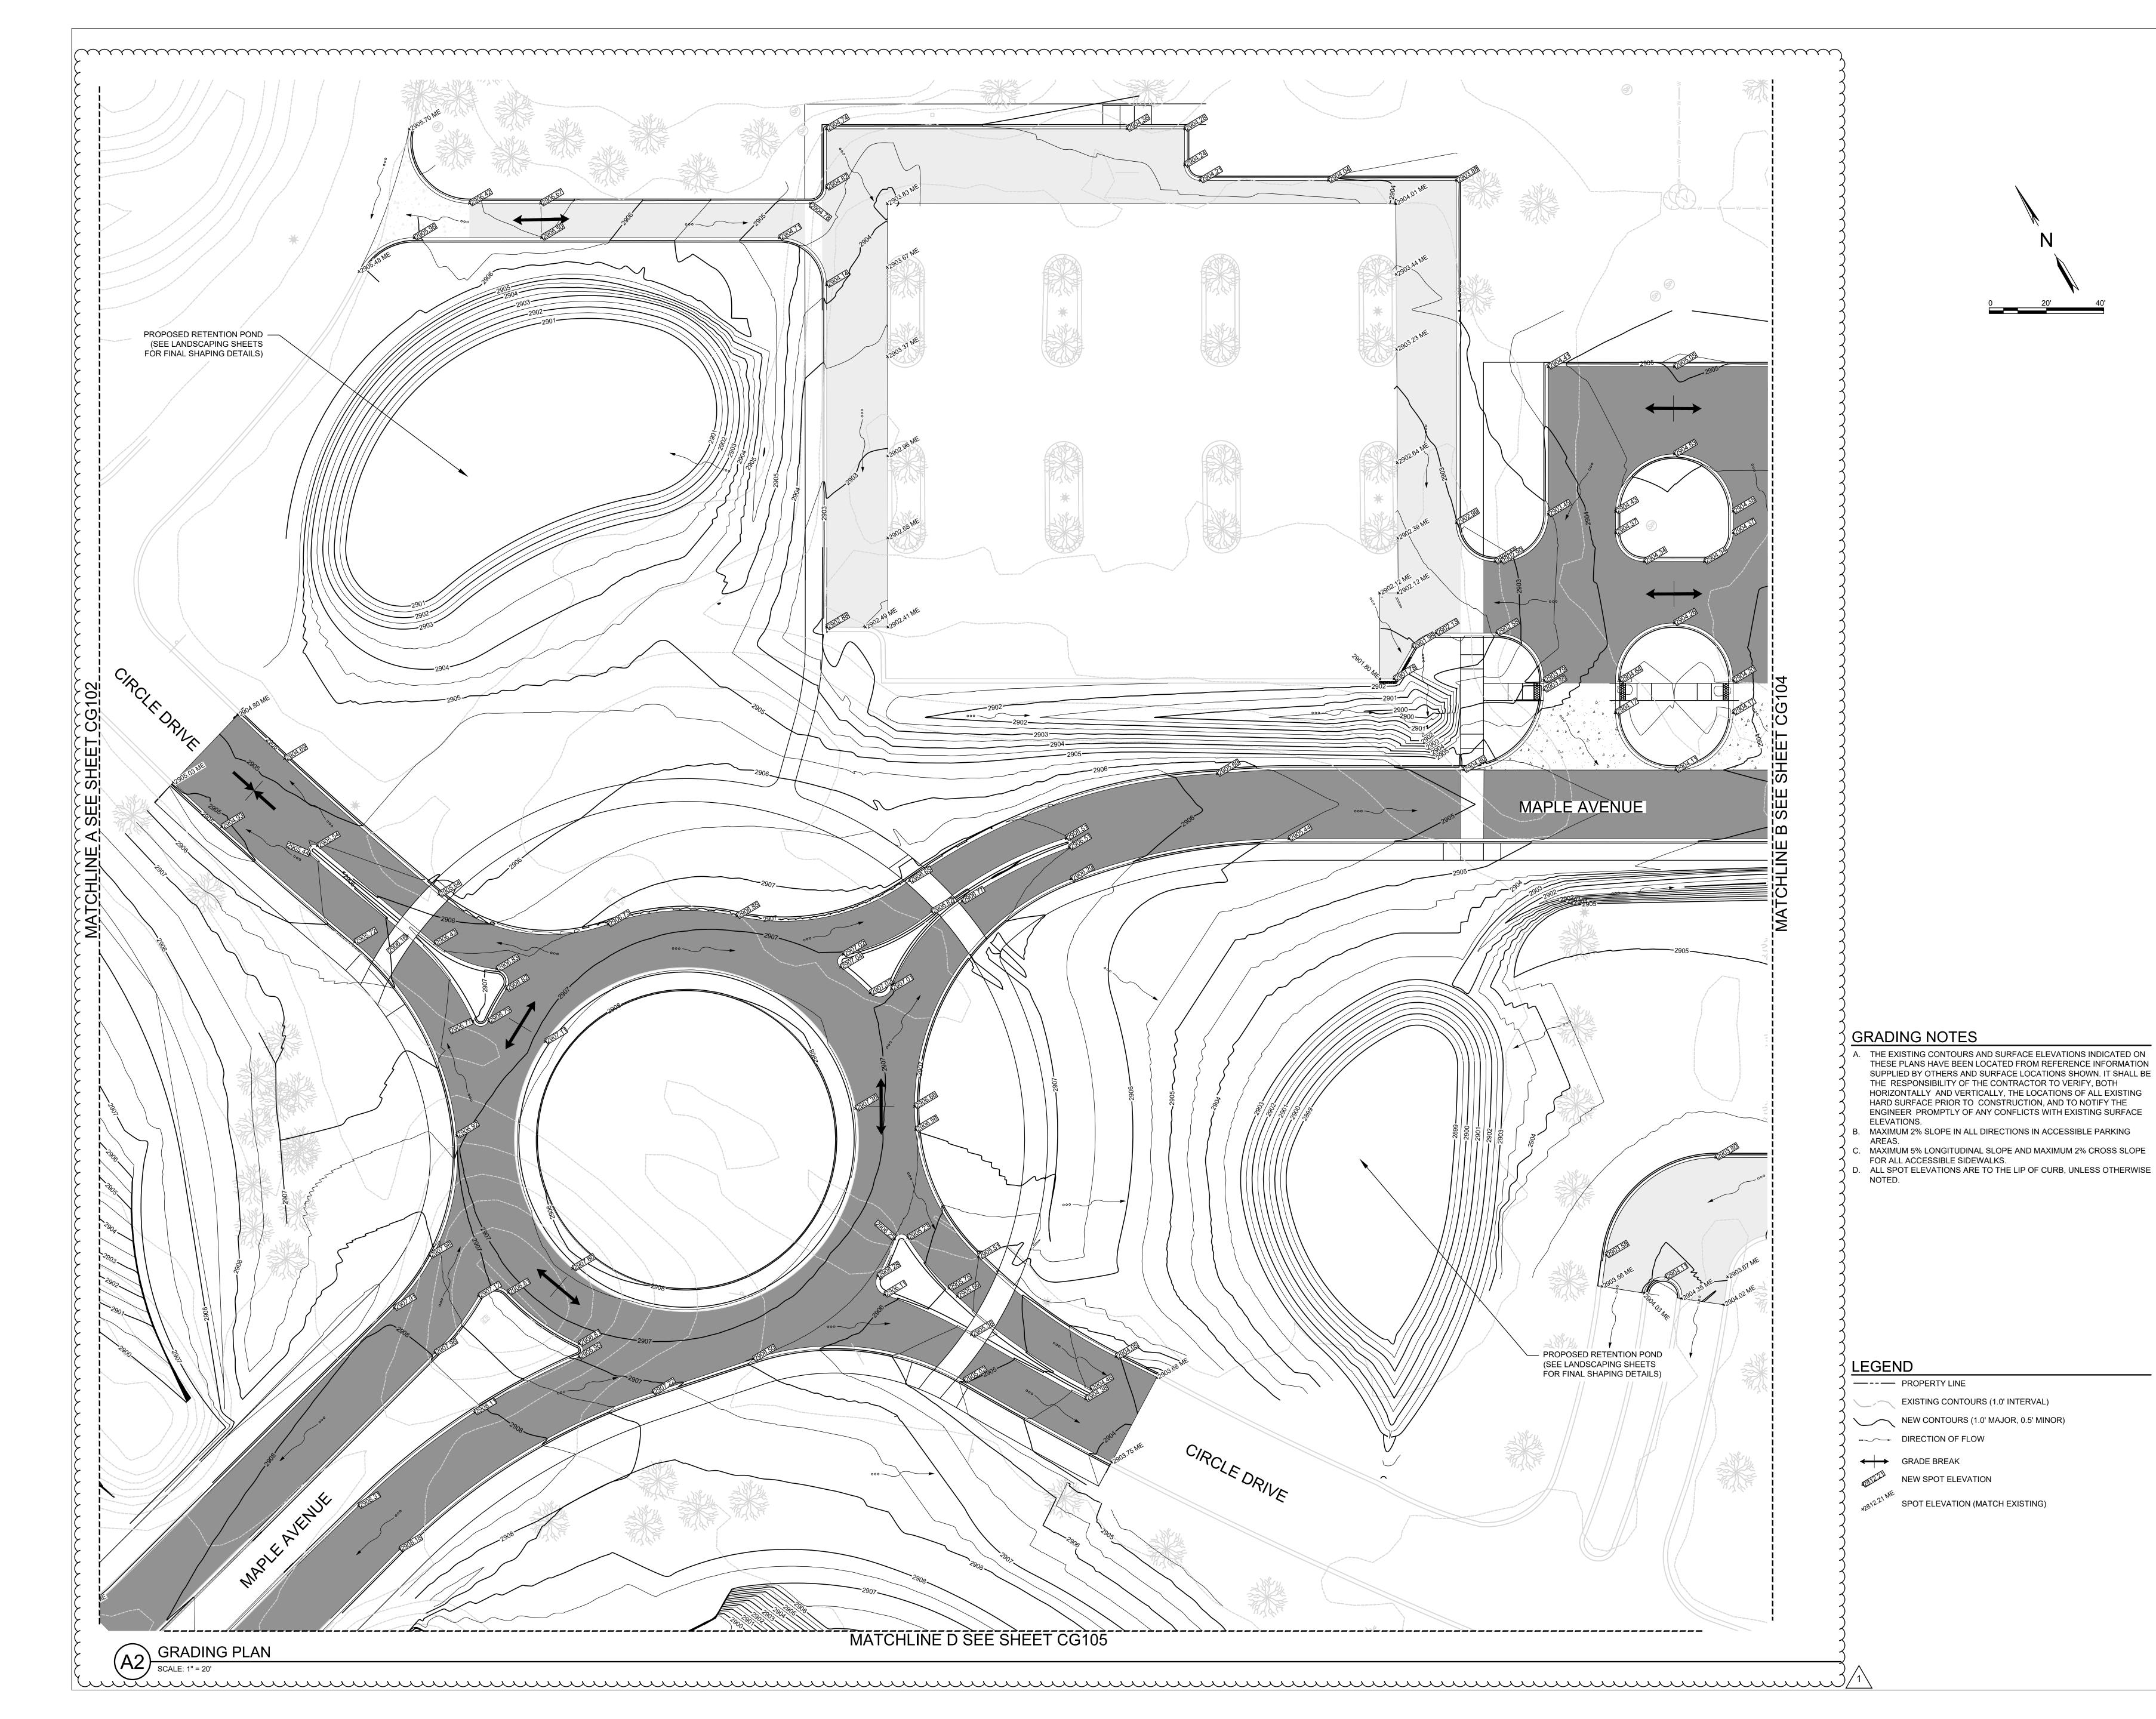

TEN EYCK LANDSCAPE ARCHITECTS

1224 EAST 12TH STREET, SUITE 323 AUSTIN, TEXAS 78702 512 813 9999 www.teneyckla.com

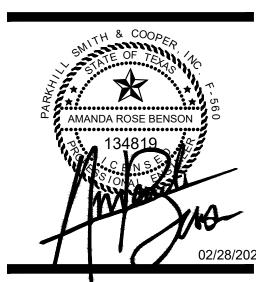

UTPB ODESSA **CAMPUS TRANSFORMATION: MAPLE ENTRY & THE QUAD**

3900 John Ben Shepperd Parkway Odessa, TX 79762

LANDSCAPE ARCHITECT TEN EYCK LANDSCAPE ARCHITECTS, INC. 1224 EAST 12TH STREET, SUITE 323 AUSTIN, TX 78702 512 813 9999 P

ARCHITECT OF RECORD

340 BEECH STREET ABILENE, TX 79601 325 673 8178 P **DESIGN ARCHITECT** LAKE FLATO ARCHITECTS 311 3RD STREET

SAN ANTONIO, TX 78205 210 227 3335 P **CIVIL ENGINEER** 1700 WEST WALL STREET, SUITE 100 MIDLAND, TX 79701

432 697 1447 P MEP ENGINEER 1701 DIRECTORS BLVD, SUITE 400 AUSTIN, TX 78744 512 445 2090 P

IRRIGATION
HINES IRRIGATION CONSULTANTS 5049 EDWARDS RANCH ROAD, FLOOR 4

FORT WORTH, TX 76109 970 233 3013 P LIGHTING DESIGN 1999 BROADWAY SUITE 2205 DENVER, CO 80202 720 644 5044 P


SIGNAGE RSM DESIGN 408 W EIGHTH STREET, SUITE 201 DALLAS, TX 75208

949 843 0713 P ARTIST

ODESSA ARTS PO BOX 7195 ODESSA, TX 79760 432 337 1492 P STRUCTURAL ENGINEER (LANDSCAPE) ARCHITECTURAL ENGINEERS COLLABORATIVE 3800 NORTH LAMAR BLVD SUITE 330 AUSTIN, TX 78756 512 472 2111 P

WATER FEATURE 2550 PACIFIC AVENUE, SUITE 700 DALLAS, TX 75226 469 320 8771 P

KEY PLAN

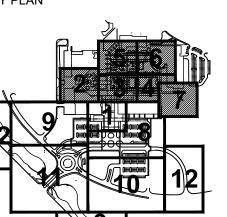

CONSTRUCTION DOCUMENTS

NO. DATE ISSUE

02/03/2025 100% IFC


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DATE: 02/28/2025

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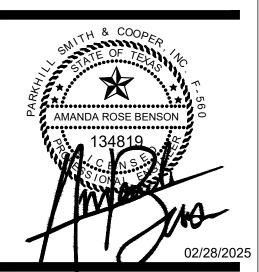
DRAWING TITLE: Grading Enlarged Views

CG103



TENEYCK LANDSCAPE ARCHITECTS

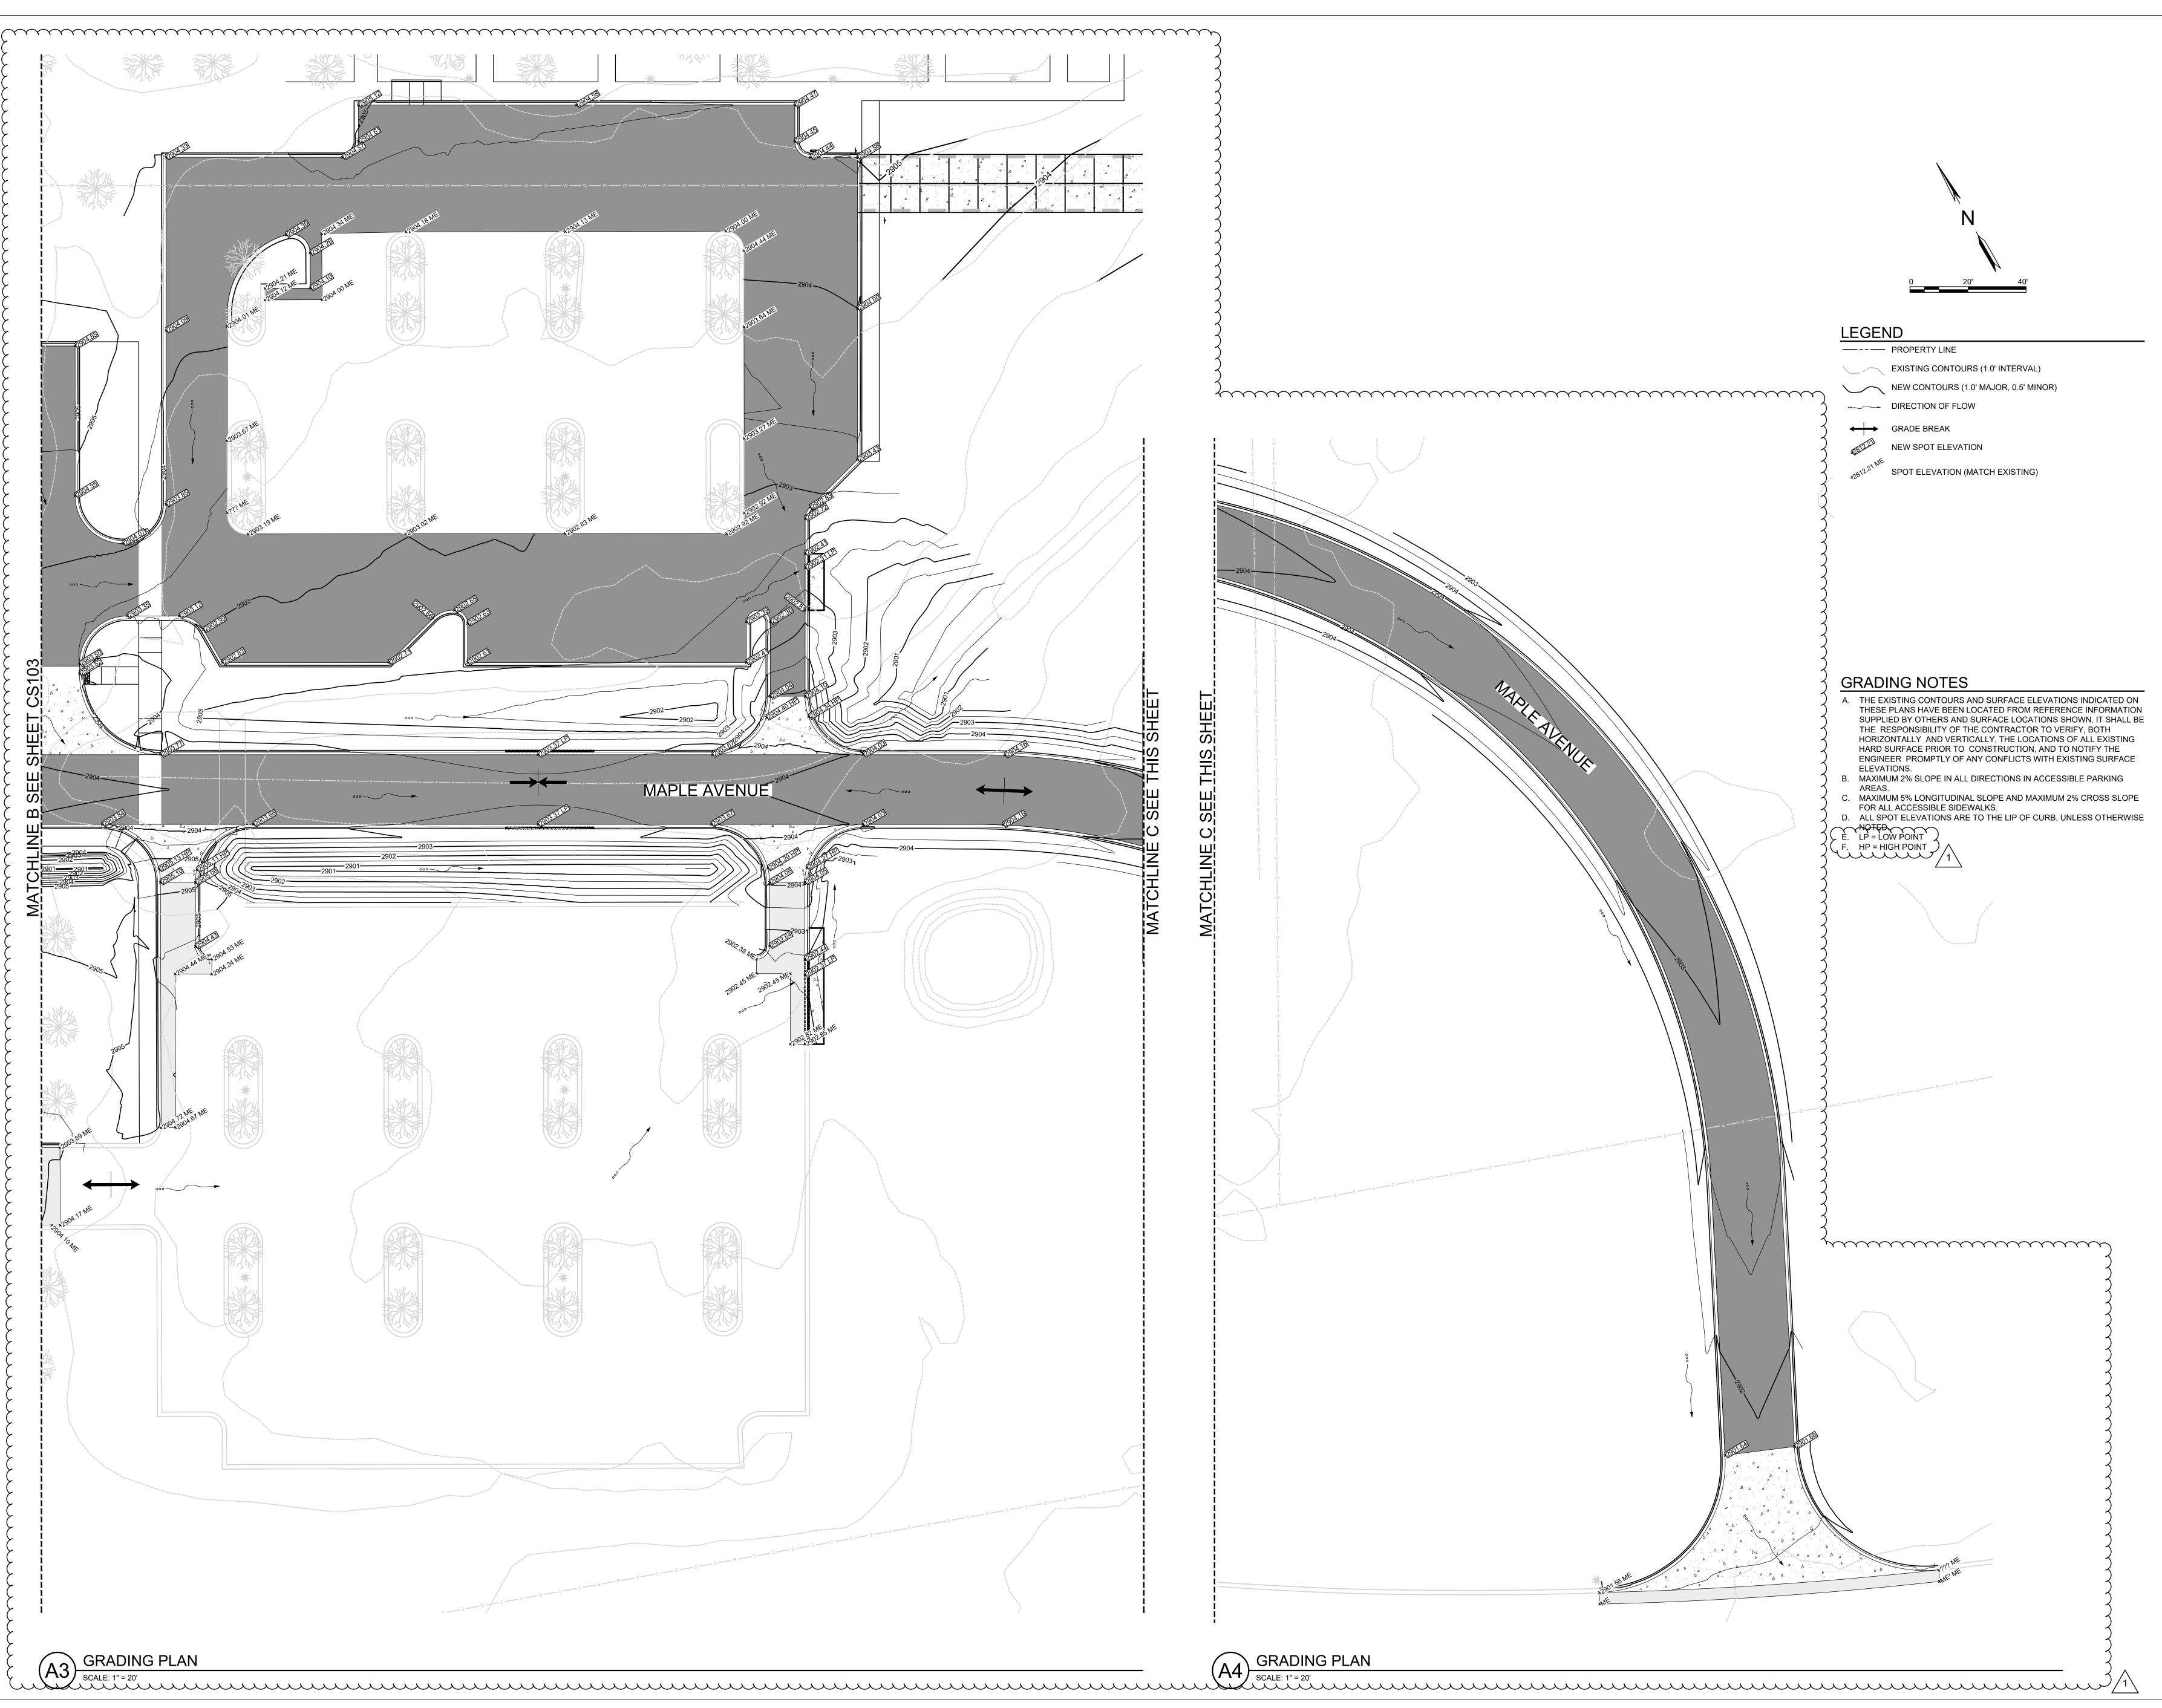1224 EAST 12TH STREET, SUITE 323 AUSTIN, TEXAS 78702 512 813 9999 www.teneyckla.com



UTPB ODESSA

CAMPUS TRANSFORMATION:
MAPLE ENTRY & THE QUAD

3900 John Ben Shepperd Parkway Odessa, TX 79762

LANDSCAPE ARCHITECT
TEN EYCK LANDSCAPE ARCHITECTS, INC.
1224 EAST 12TH STREET, SUITE 323
AUSTIN, TX 78702
512 813 9999 P

512 813 9999 P

ARCHITECT OF RECORD

PARKHILL

340 BEECH STREET

ABILENE, TX 79601

325 673 8178 P

DESIGN ARCHITECT
LAKE FLATO ARCHITECTS
311 3RD STREET
SAN ANTONIO, TX 78205
210 227 3335 P

SAN ANTONIO, TX 78205 210 227 3335 P

CIVIL ENGINEER

PARKHILL
1700 WEST WALL STREET, SUITE 100
MIDLAND, TX 79701

432 697 1447 P

MEP ENGINEER

GUERRA 1701 DIRECTORS BLVD, SUITE 400 AUSTIN, TX 78744 512 445 2090 P IRRIGATION

IRRIGATION
HINES IRRIGATION CONSULTANTS
5049 EDWARDS RANCH ROAD, FLOOR 4
FORT WORTH, TX 76109

FORT WORTH, TX 76109
970 233 3013 P

LIGHTING DESIGN

MAZZETTI
1999 BROADWAY SUITE 2205
DENVER, CO 80202
720 644 5044 P

SIGNAGE
RSM DESIGN
408 W EIGHTH STREET, SUITE 201
DALLAS, TX 75208

DALLAS, TX 75208 949 843 0713 P

ODESSA ARTS PO BOX 7195 ODESSA, TX 79760 432 337 1492 P

STRUCTURAL ENGINEER (LANDSCAPE)
ARCHITECTURAL ENGINEERS COLLABORATIVE
3800 NORTH LAMAR BLVD SUITE 330
AUSTIN, TX 78756
512 472 2111 P


512 472 2111 P

WATER FEATURE

OTL

OTL 2550 PACIFIC AVENUE, SUITE 700 DALLAS, TX 75226 469 320 8771 P

KEY DI ANI

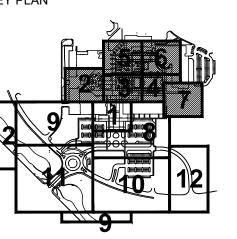

PHASE:
CONSTRUCTION DOCUMENTS

NO. DATE ISSUE

02/03/2025 100% IFC

02/28/2025 ADDENDUM NO2

DATE: 02/28/2025


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TELA PROJECT NO: 22013.00

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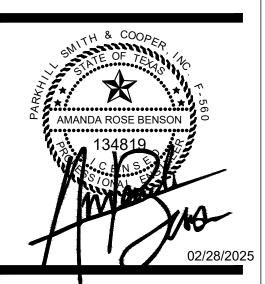
Grading
Enlarged Views
CG104



LANDSCAPE ARCHITECTS

1224 EAST 12TH STREET, SUITE 323
AUSTIN, TEXAS 78702
512 813 9999

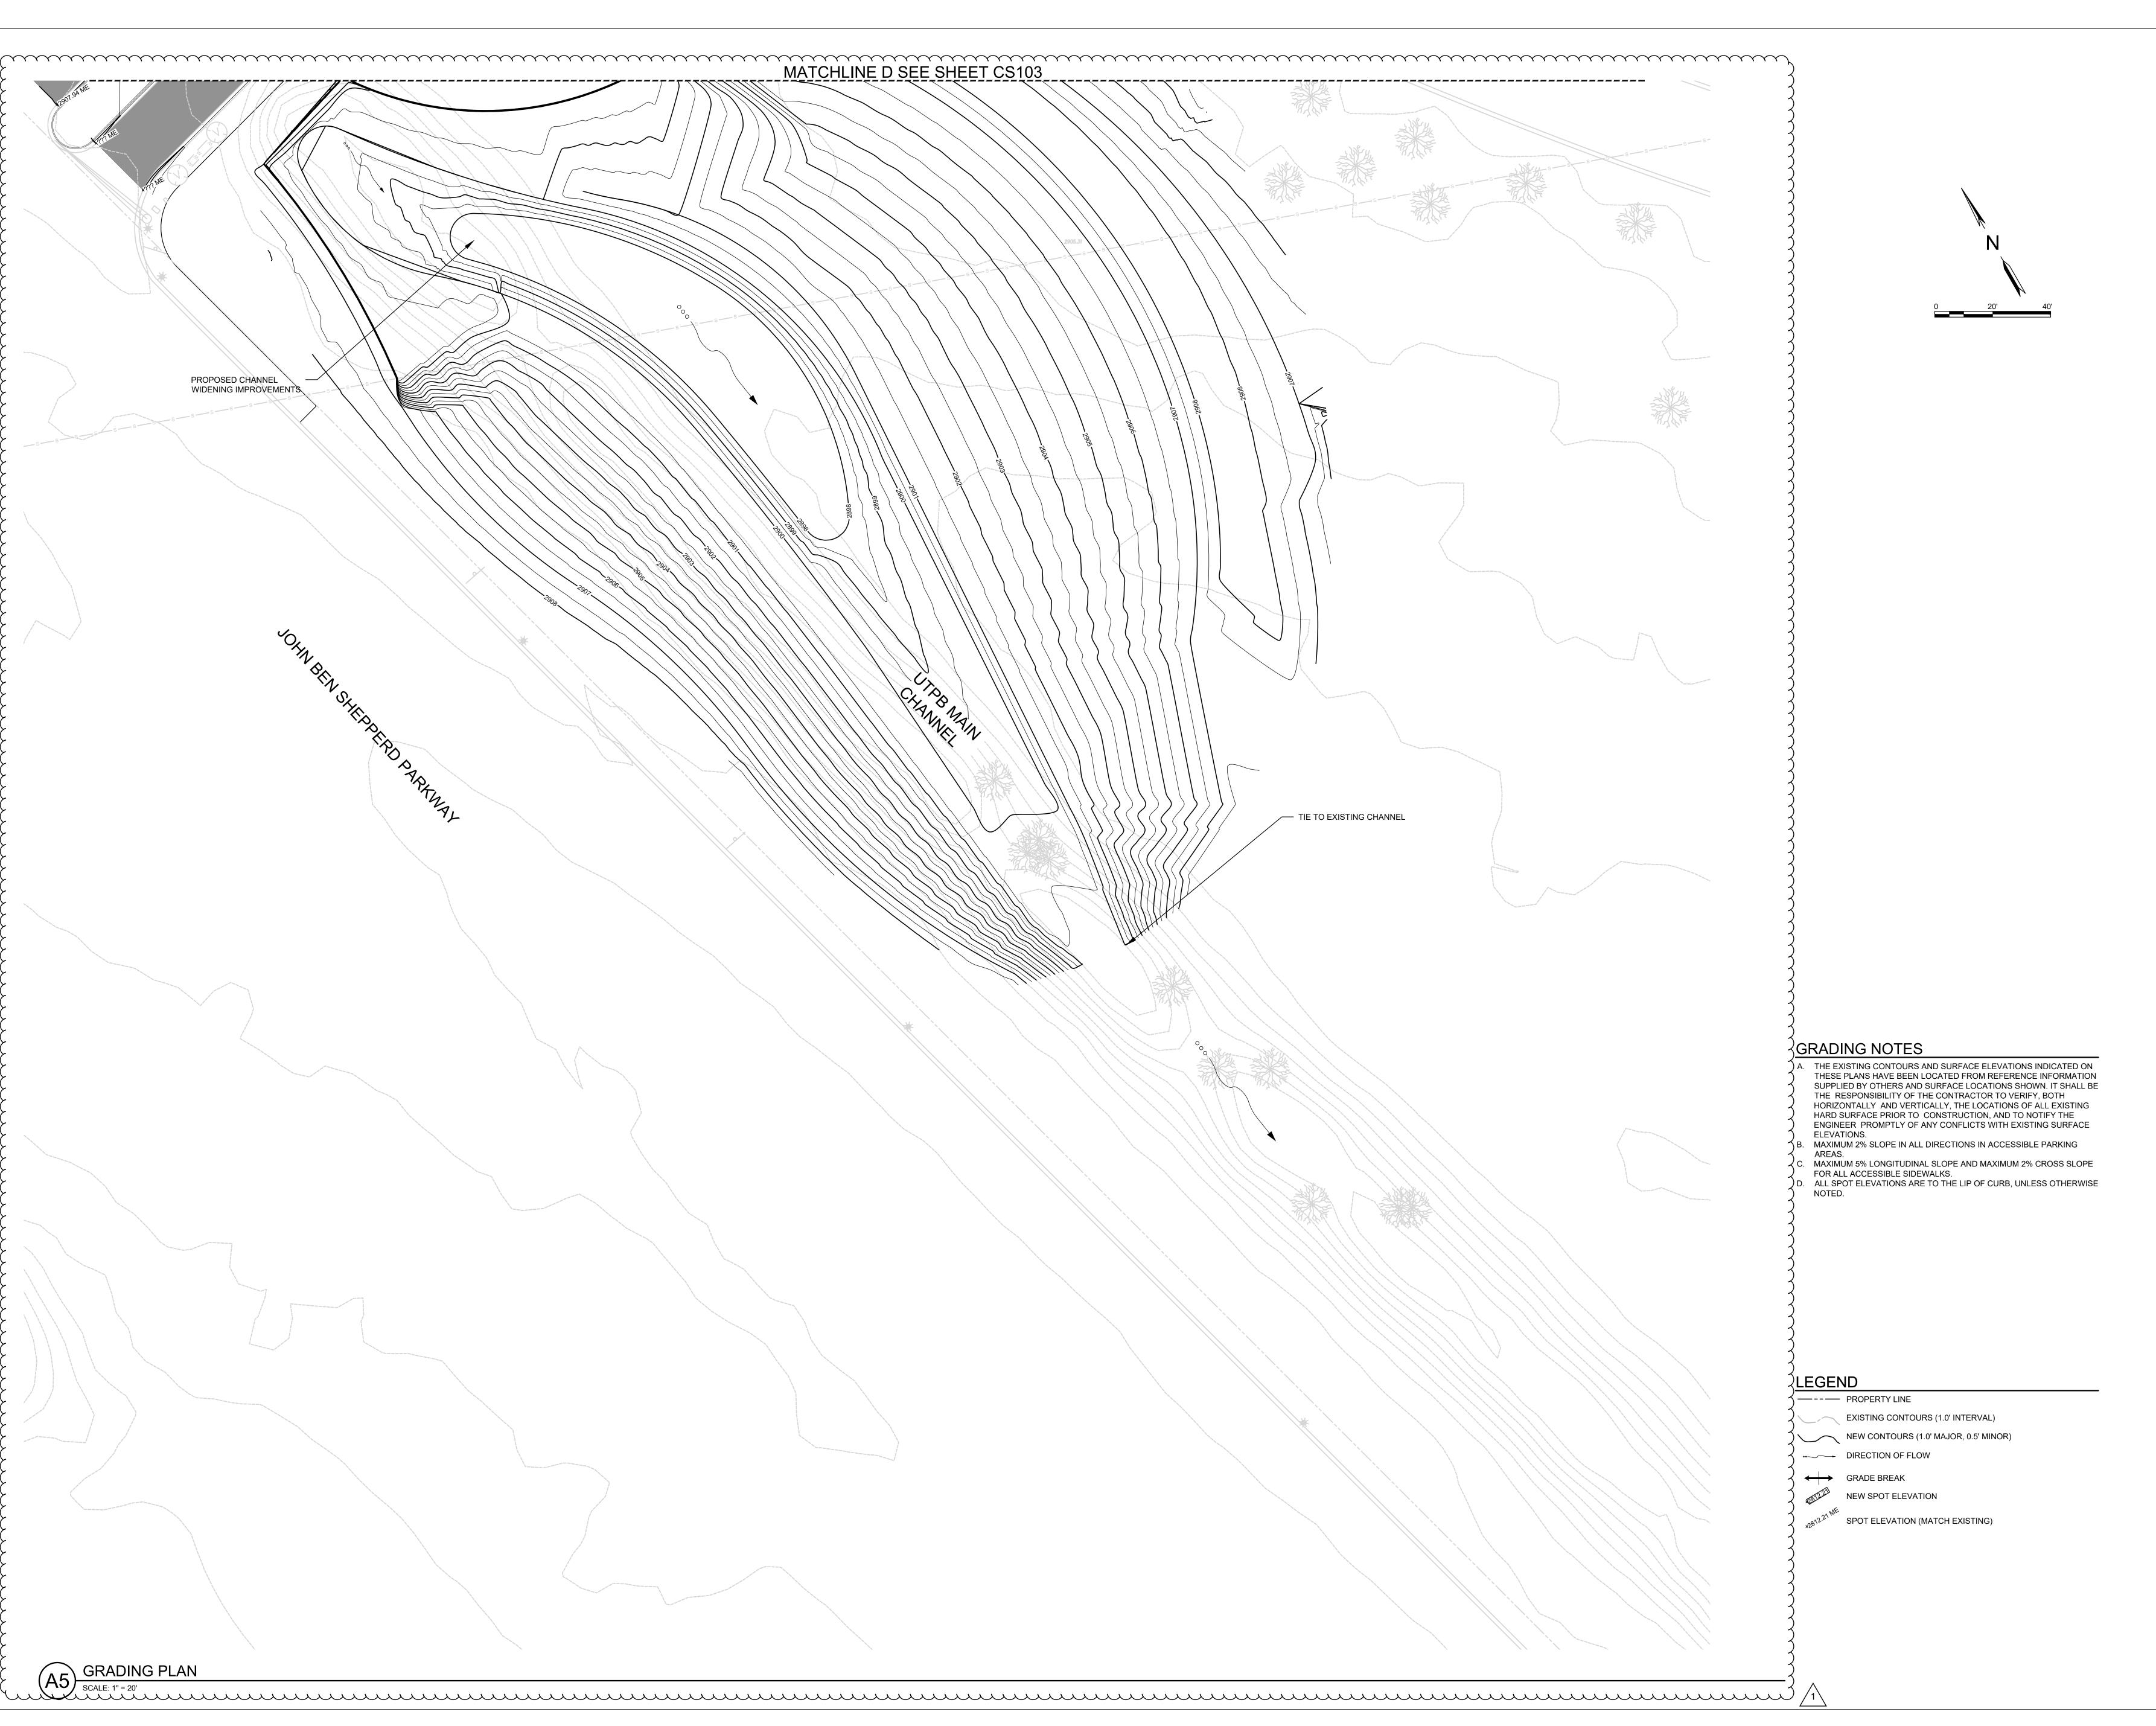www.teneyckla.com



UTPB ODESSA
CAMPUS TRANSFORMATION:
MAPLE ENTRY & THE QUAD

3900 John Ben Shepperd Parkway Odessa, TX 79762

LANDSCAPE ARCHITECT
TEN EYCK LANDSCAPE ARCHITECTS, INC.
1224 EAST 12TH STREET, SUITE 323
AUSTIN, TX 78702
512 813 9999 P

ARCHITECT OF RECORD PARKHILL 340 BEECH STREET ABILENE, TX 79601 325 673 8178 P

DESIGN ARCHITECT LAKE FLATO ARCHITECTS 311 3RD STREET SAN ANTONIO, TX 78205 210 227 3335 P

CIVIL ENGINEER
PARKHILL
1700 WEST WALL STREET, SUITE 100
MIDLAND, TX 79701
432 697 1447 P

MEP ENGINEER

1701 DIRECTORS BLVD, SUITE 400
AUSTIN, TX 78744
512 445 2090 P

IRRIGATION
HINES IRRIGATION CONSULTANTS

HINES IRRIGATION CONSULTANTS
5049 EDWARDS RANCH ROAD, FLOOR 4
FORT WORTH, TX 76109
970 233 3013 P

LIGHTING DESIGN

1999 BROADWAY SUITE 2205 DENVER, CO 80202 720 644 5044 P SIGNAGE RSM DESIGN 408 W EIGHTH STREET, SUITE 201

DALLAS, TX 75208
949 843 0713 P

ARTIST


ODESSA ARTS

ODESSA ARTS
PO BOX 7195
ODESSA, TX 79760
432 337 1492 P

STRUCTURAL ENGINEER (LANDSCAPE)
ARCHITECTURAL ENGINEERS COLLABORATIVE
3800 NORTH LAMAR BLVD SUITE 330
AUSTIN, TX 78756
512 472 2111 P

WATER FEATURE
OTL
2550 PACIFIC AVENUE, SUITE 700
DALLAS, TX 75226
469 320 8771 P

KEV DI AN

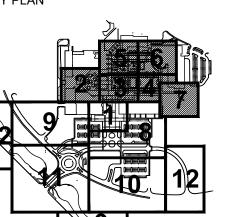

CONSTRUCTION DOCUMENTS

NO. DATE ISSUE

02/03/2025 100% IFC

1 02/28/2025 ADDENDUM NO2

DATE: 02/28/2025

DRAWN: PARKHILL


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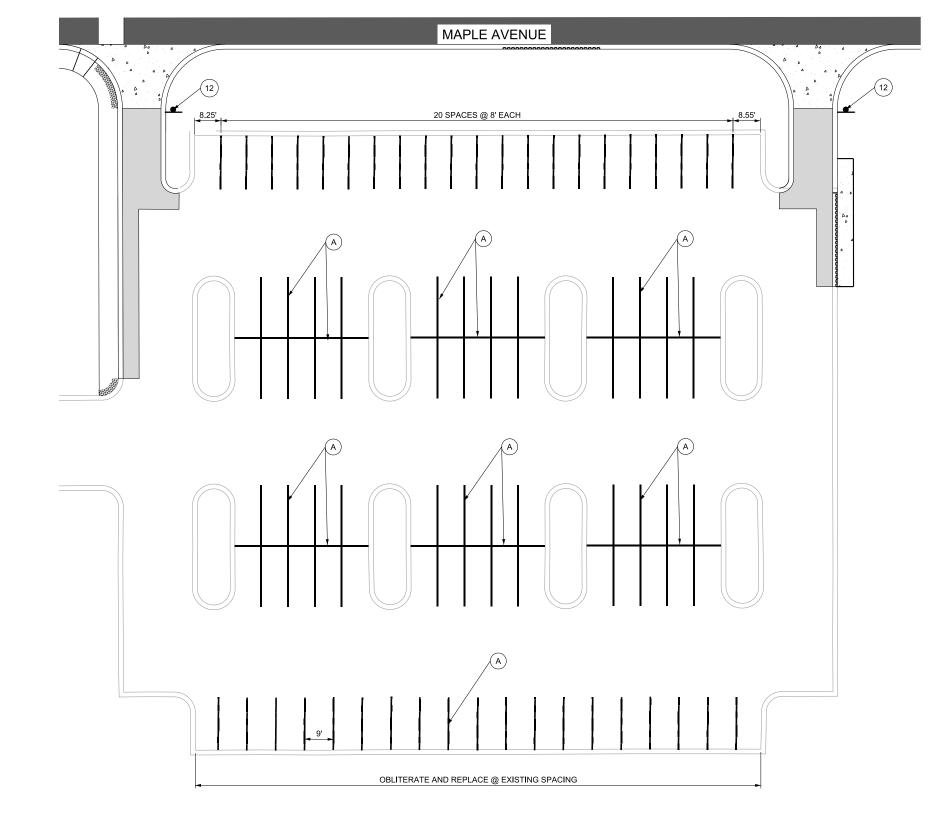
TELA PROJECT NO: 22013.00


DRAWING TITLE:

Grading
Enlarged Views


CG105



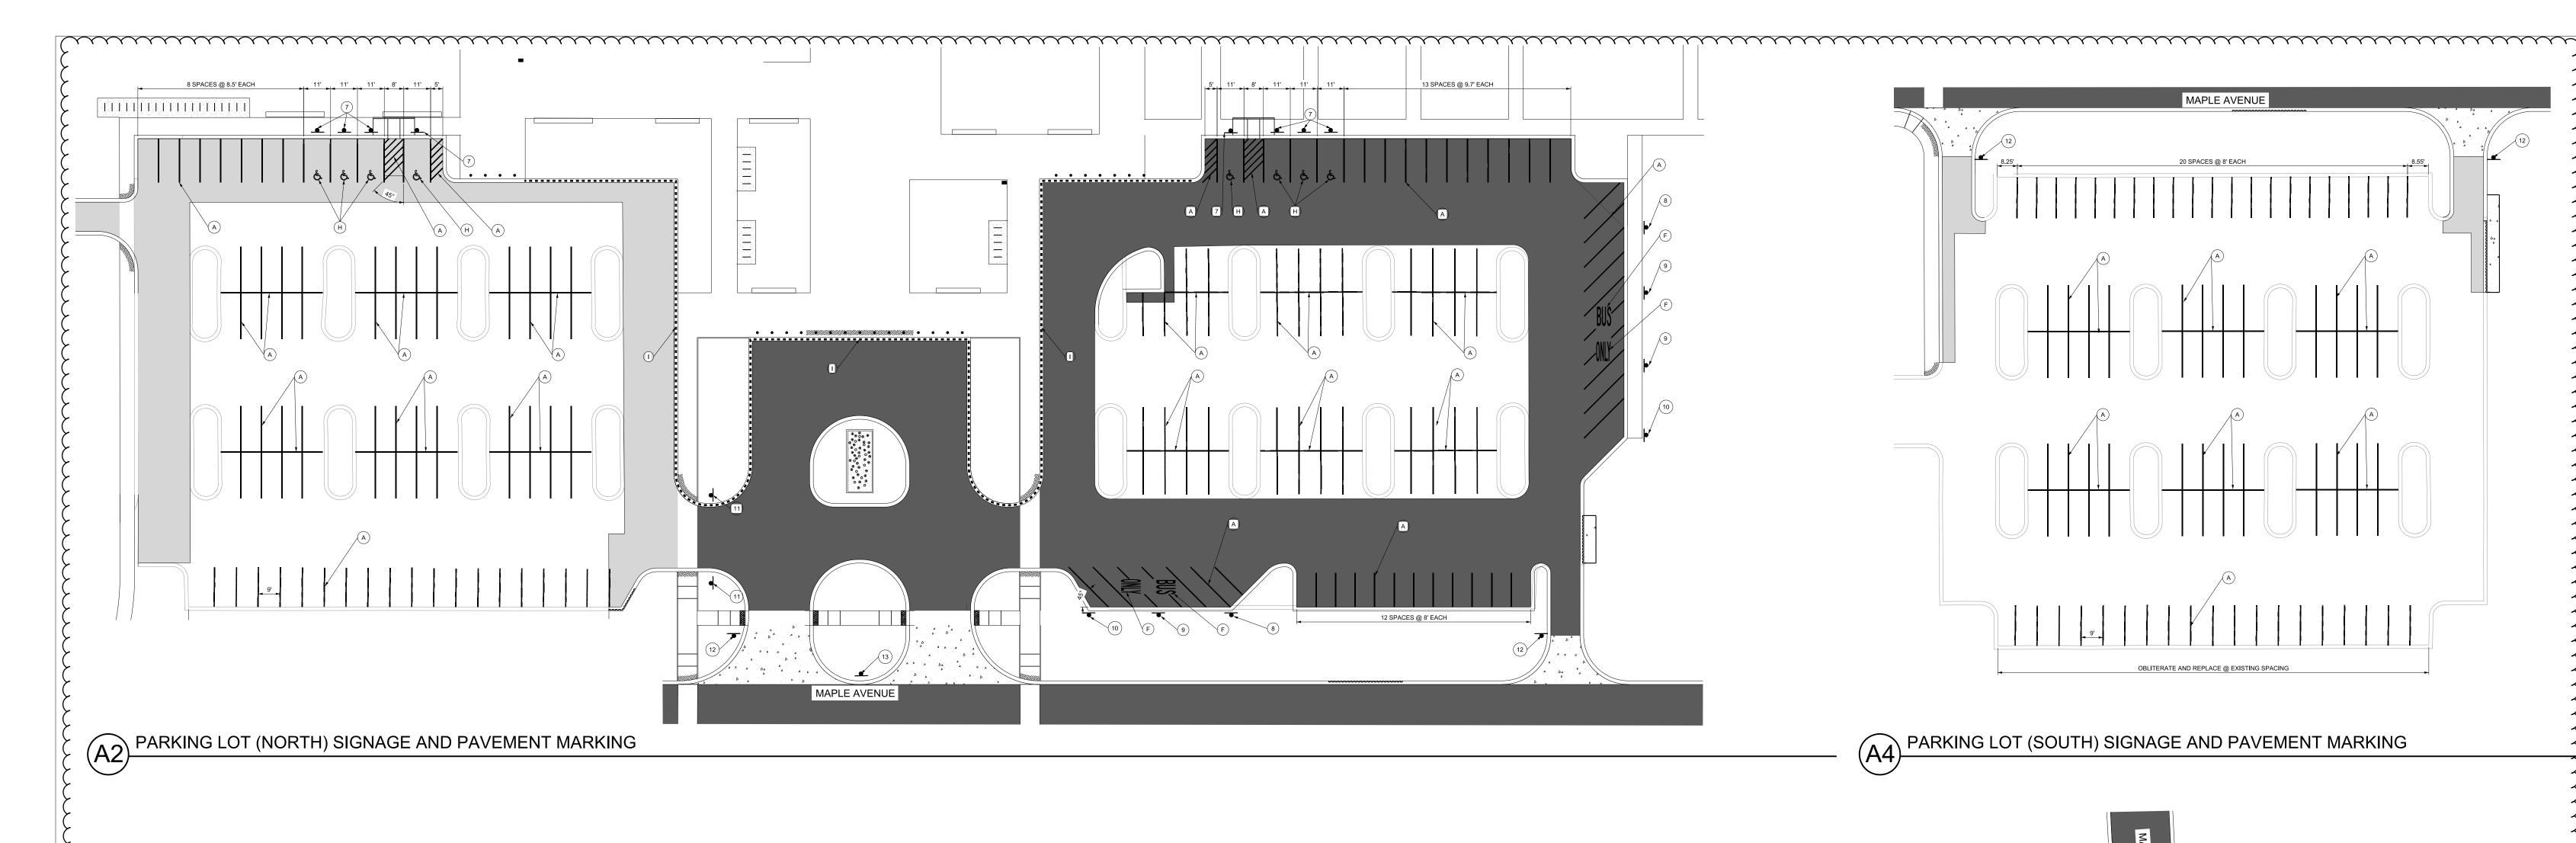

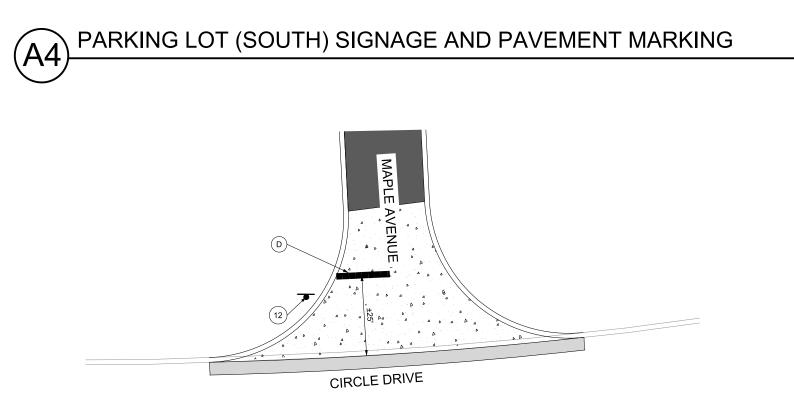

MAPLE AVENUE AND CIRCLE DRIVE INTERSECTION SIGNAGE AND PAVEMENT MARKING

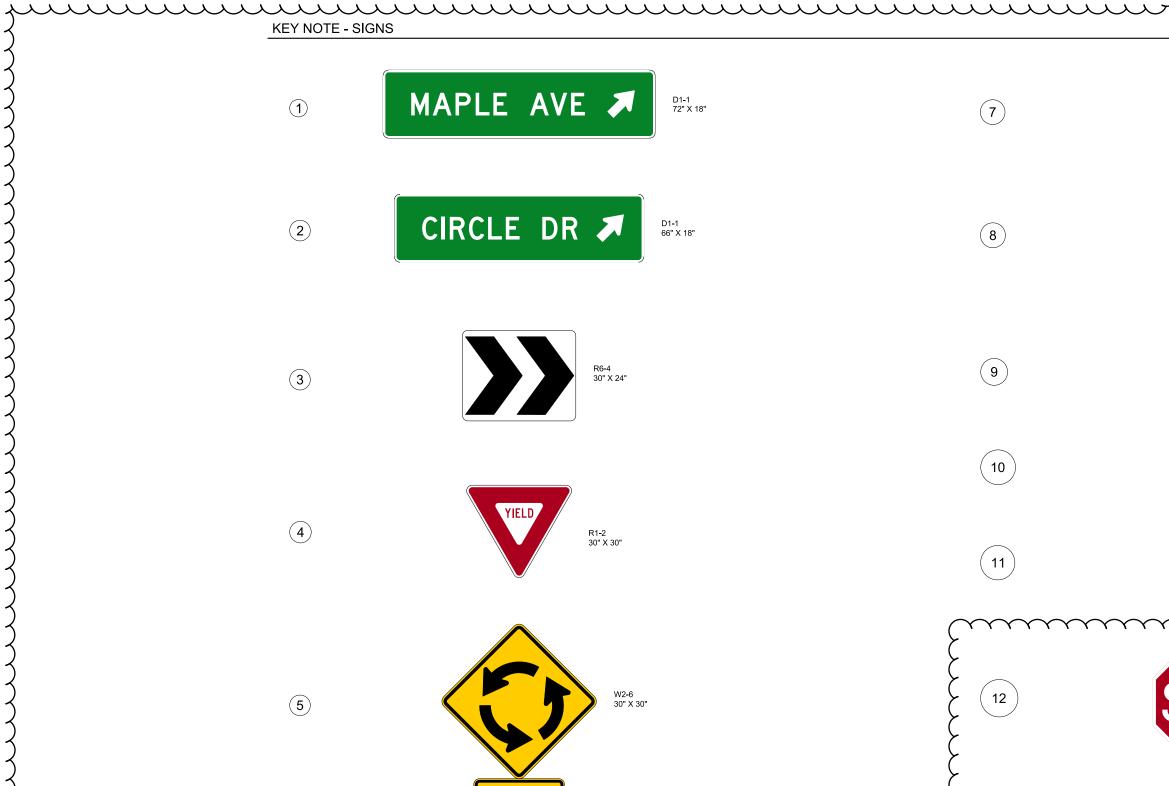




NOTES 1. CURBS NOTED AS "FIRE LANE NO PARKING" SHALL BE PAINTED RED AND MARKED WITH "NO PARKING FIRE LANE" IN WHITE 4" LETTERS AT INTERVALS NOT EXCEEDING 50'


2. ALL SIGNS ARE TO BE PERMANENTLY INSTALLED WITH 10BWG TUBING AND TRIANGULAR SLIP BASE MOUNTING. SYSTEM.

3. ALL PAVEMENT MARKING SHALL COMPLY WITH TXDOT ITEM 666, TYPE IN PEOUL IDEMENTS. II REQUIREMENTS.

4. REFER TO DETAIL CM501 FOR POLE AND MOUNTING HEIGHTS

5. MAINTAIN EXISTING CONFIGURATION AND WIDTHS IN AREAS WHERE
EXISTING PAVEMENT TO REMAIN. ALL PAVEMENTS SHALL RECEIVE
NEW PARKING LOT STALL STRIPING AS SHOWN.

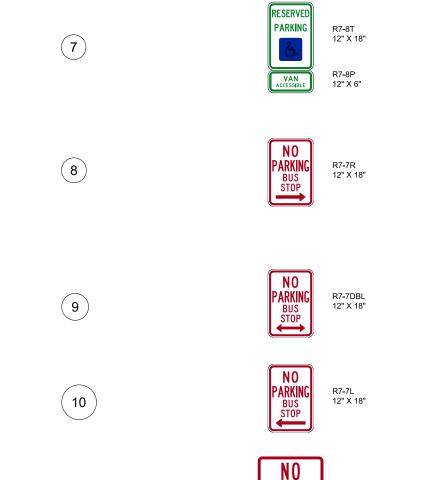


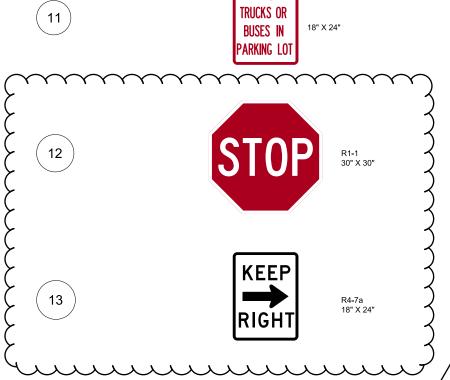

KEY NOTE - STRIPING A 4" WHITE SOLID G 18" X 12" YIELD TRIANGLE B 6" YELLOW SOLID H ACCESSIBILITY PARKING SYMBOL C 6" WHITE SOLID FIRE LANE MARKING Comment of the second J 8" WHITE SOLID D 8" WHITE DOTTED (K) WHITE ARROW E 24" WHITE SOLID F WHITE WORD

TEN EYCK

LANDSCAPE ARCHITECTS 1224 EAST 12TH STREET, SUITE 323 AUSTIN, TEXAS 78702 512 813 9999 www.teneyckla.com

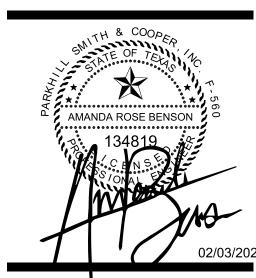

UTPB ODESSA **CAMPUS TRANSFORMATION: MAPLE ENTRY & THE QUAD**

3900 John Ben Shepperd Parkway Odessa, TX 79762

TEN EYCK LANDSCAPE ARCHITECTS, INC. 1224 EAST 12TH STREET, SUITE 323 AUSTIN, TX 78702 512 813 9999 P

ARCHITECT OF RECORD PARKHILL 340 BEECH STREET ABILENE, TX 79601 325 673 8178 P **DESIGN ARCHITECT** LAKE FLATO ARCHITECTS 311 3RD STREET

SAN ANTONIO, TX 78205 210 227 3335 P **CIVIL ENGINEER** 1700 WEST WALL STREET, SUITE 100 MIDLAND, TX 79701 432 697 1447 P MEP ENGINEER


1701 DIRECTORS BLVD, SUITE 400 AUSTIN, TX 78744 512 445 2090 P IRRIGATION

HINES IRRIGATION CONSULTANTS 5049 EDWARDS RANCH ROAD, FLOOR 4 FORT WORTH, TX 76109 970 233 3013 P LIGHTING DESIGN

1999 BROADWAY SUITE 2205 DENVER, CO 80202 720 644 5044 P SIGNAGE RSM DESIGN 408 W EIGHTH STREET, SUITE 201 DALLAS, TX 75208 949 843 0713 P

> ARTIST ODESSA ARTS PO BOX 7195 ODESSA, TX 79760 432 337 1492 P STRUCTURAL ENGINEER (LANDSCAPE)

ARCHITECTURAL ENGINEERS COLLABORATIVE 3800 NORTH LAMAR BLVD SUITE 330 AUSTIN, TX 78756 512 472 2111 P WATER FEATURE 2550 PACIFIC AVENUE, SUITE 700 DALLAS, TX 75226 469 320 8771 P

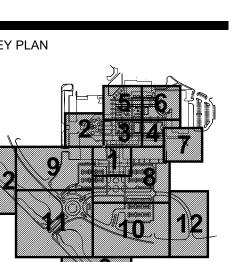


CONSTRUCTION DOCUMENTS


NO. DATE ISSUE 02/03/2025 100% IFC 02/28/2025 ADDENDUM NO2

DATE: 02/28/2025 DRAWN: PARKHILL CHECKED: PARKHILL

TELA PROJECT NO: 22013.00 DRAWING TITLE:

Pavement Marking and Signage CM101

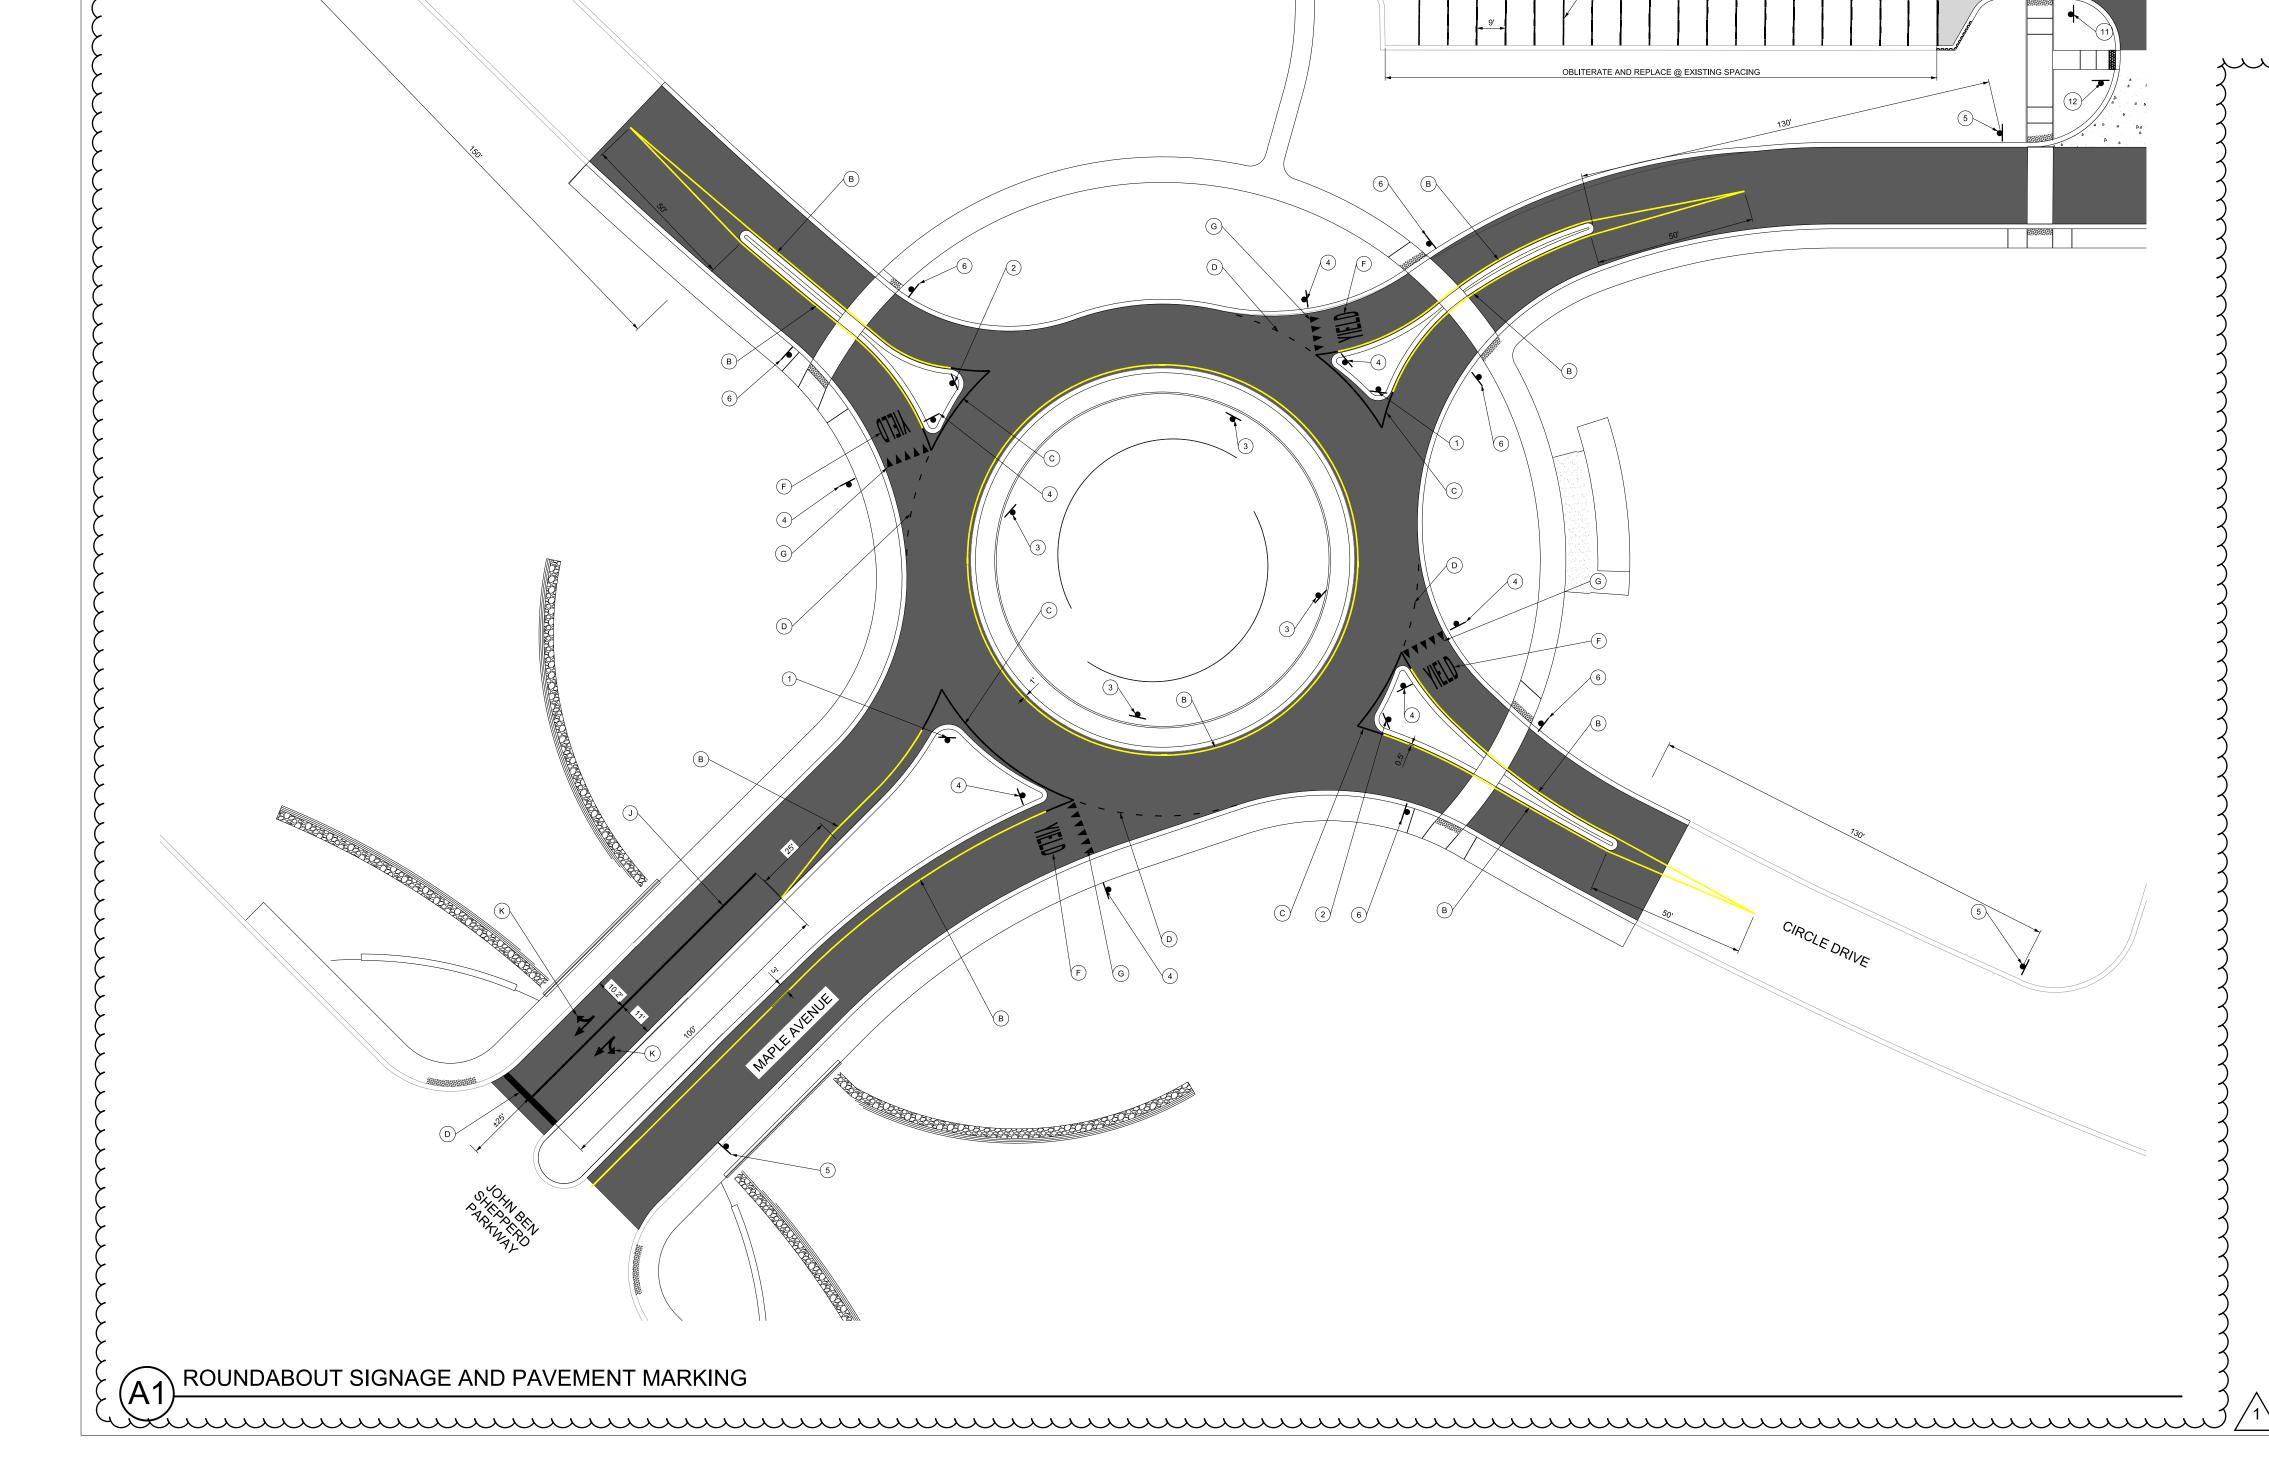

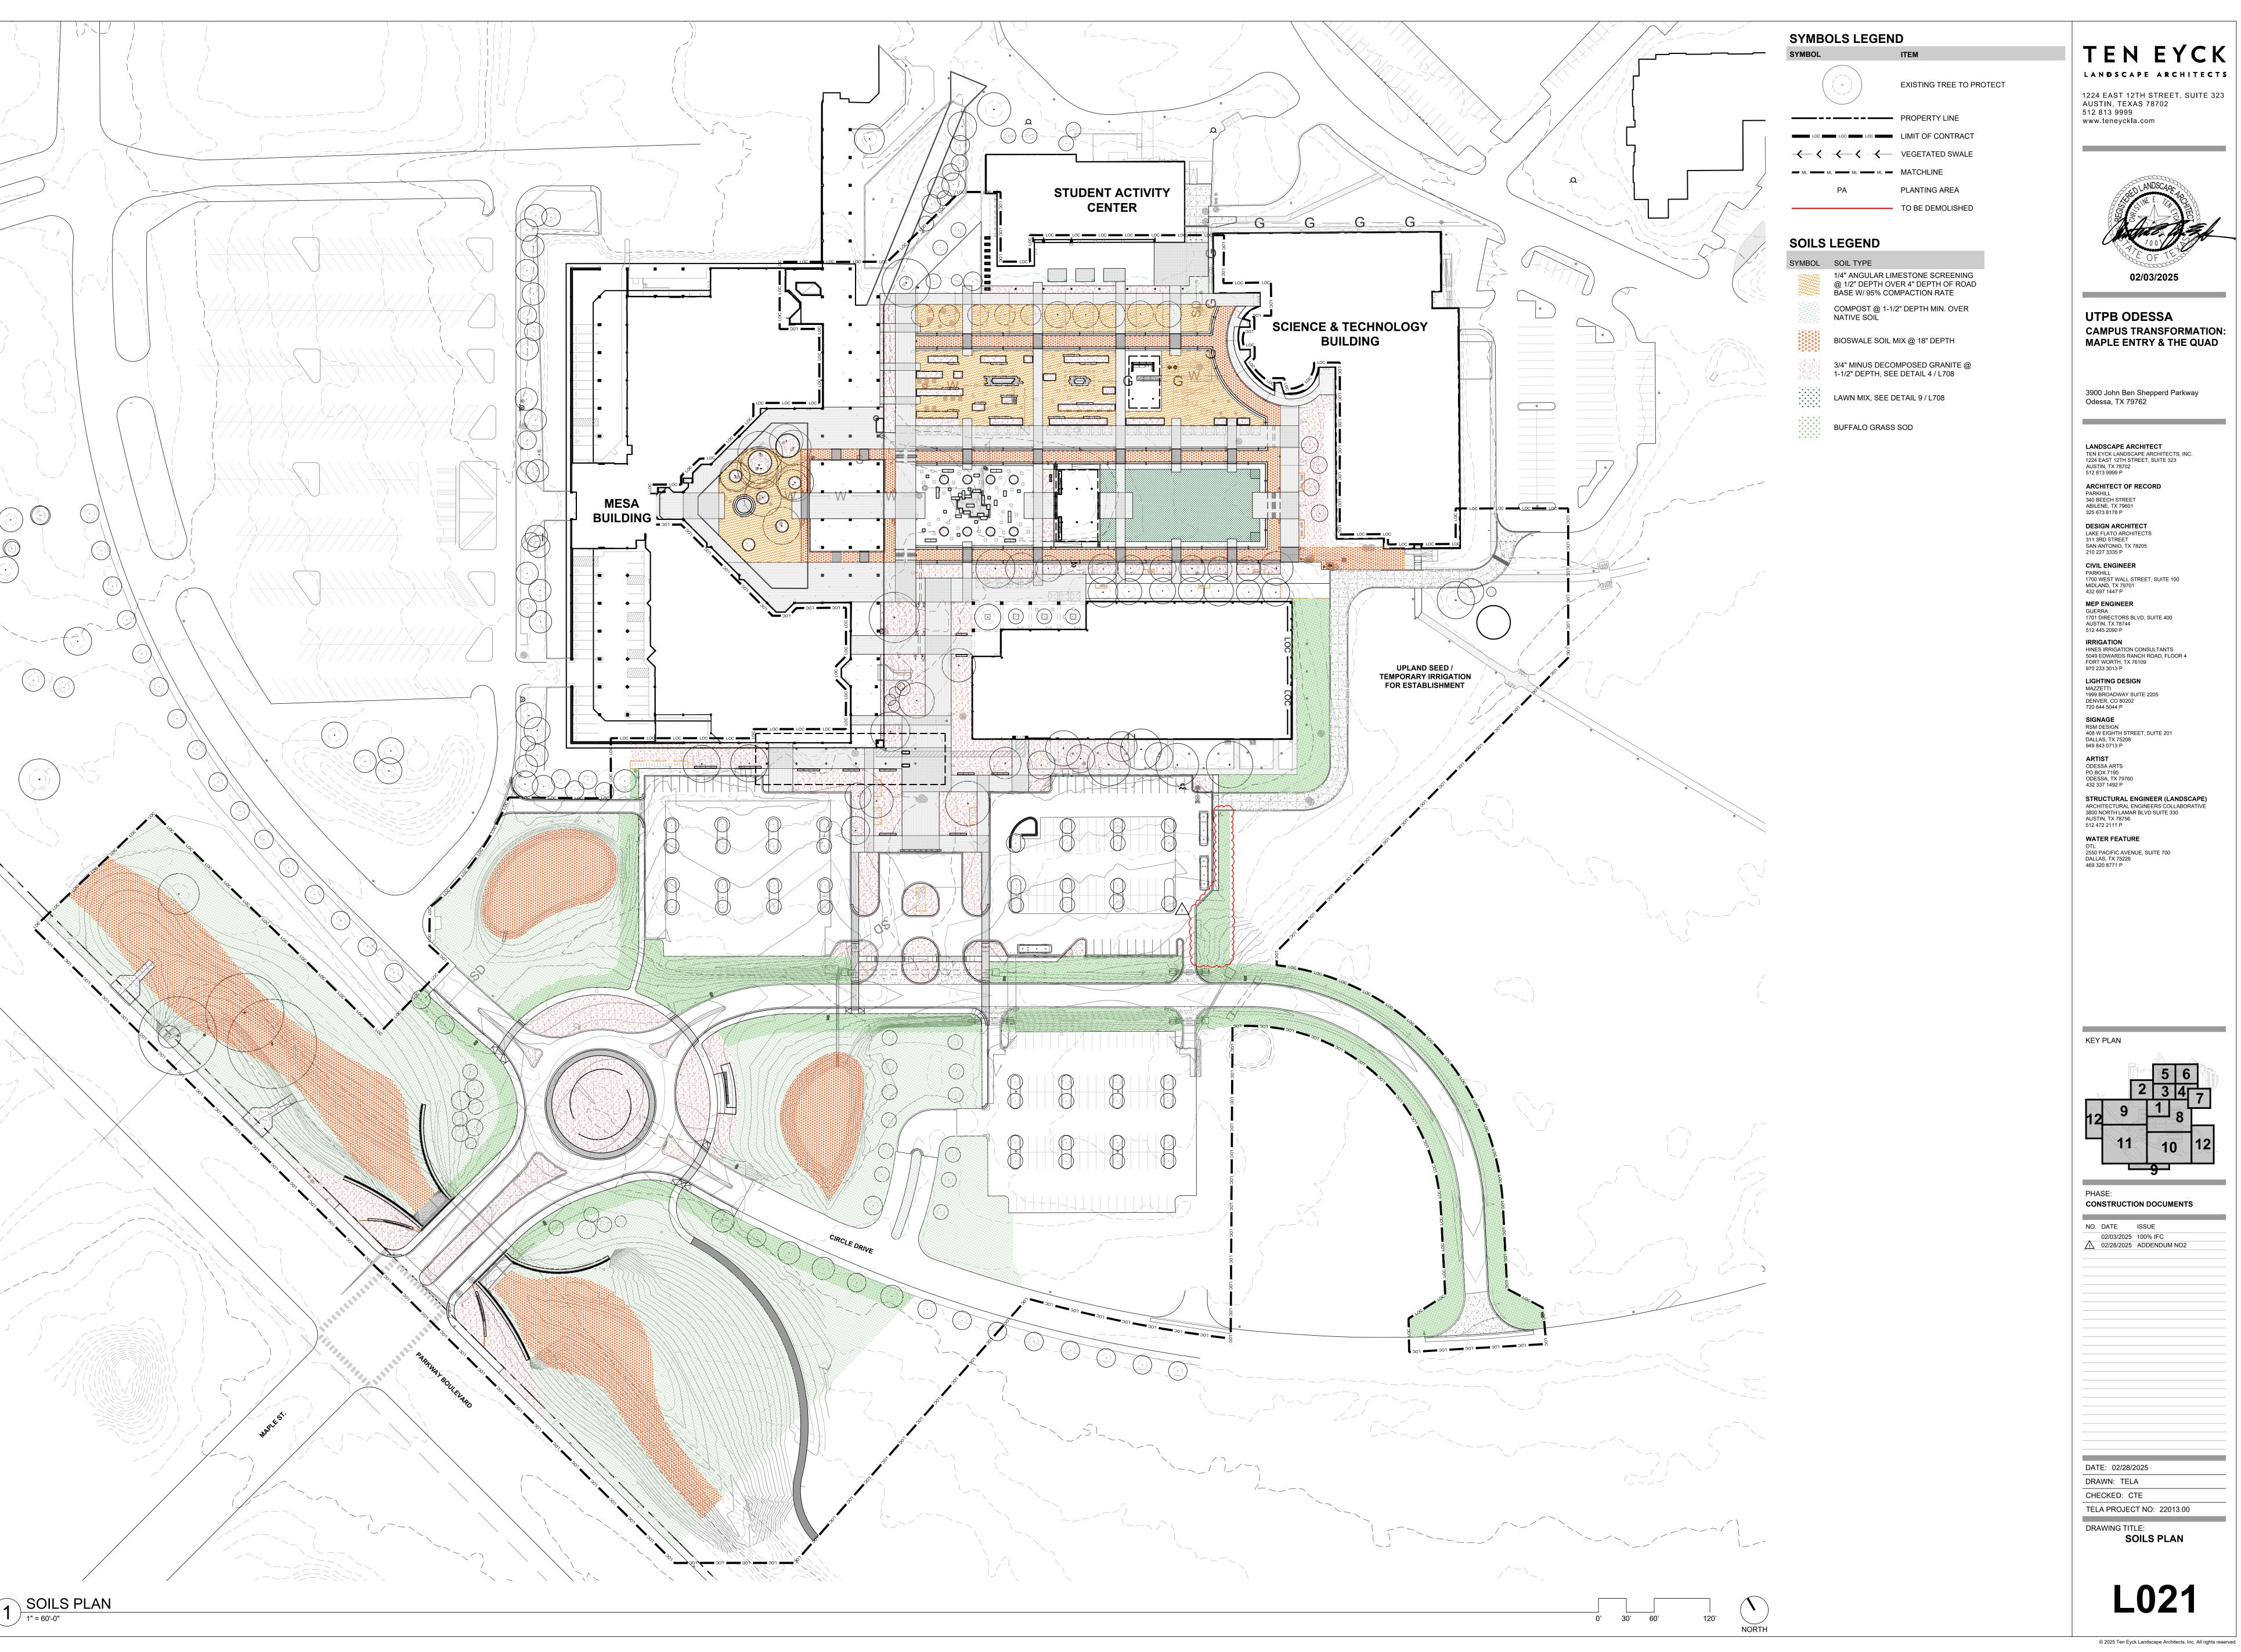

LANDSCAPE ARCHITECTS

1224 EAST 12TH STREET, SUITE 323 AUSTIN, TEXAS 78702 512 813 9999 www.teneyckla.com



UTPB ODESSA CAMPUS TRANSFORMATION: MAPLE ENTRY & THE QUAD

3900 John Ben Shepperd Parkway Odessa, TX 79762

LANDSCAPE ARCHITECT
TEN EYCK LANDSCAPE ARCHITECTS, INC.
1224 EAST 12TH STREET, SUITE 323
AUSTIN, TX 78702
512 813 9999 P ARCHITECT OF RECORD

DESIGN ARCHITECT LAKE FLATO ARCHITECTS 311 3RD STREET SAN ANTONIO, TX 78205 210 227 3335 P

CIVIL ENGINEER

1700 WEST WALL STREET, SUITE 100 MIDLAND, TX 79701 432 697 1447 P MEP ENGINEER

1701 DIRECTORS BLVD, SUITE 400 AUSTIN, TX 78744 512 445 2090 P

IRRIGATION
HINES IRRIGATION CONSULTANTS
5049 EDWARDS RANCH ROAD, FLOOR 4
FORT WORTH, TX 76109 970 233 3013 P

1999 BROADWAY SUITE 2205 DENVER, CO 80202 720 644 5044 P


RSM DESIGN 408 W EIGHTH STREET, SUITE 201 DALLAS, TX 75208 949 843 0713 P

ARTIST ODESSA ARTS PO BOX 7195 ODESSA, TX 79760 432 337 1492 P

STRUCTURAL ENGINEER (LANDSCAPE) ARCHITECTURAL ENGINEERS COLLABORATIVE 3800 NORTH LAMAR BLVD SUITE 330 AUSTIN, TX 78756 512 472 2111 P

WATER FEATURE

2550 PACIFIC AVENUE, SUITE 700 DALLAS, TX 75226 469 320 8771 P

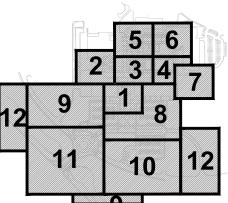

CONSTRUCTION DOCUMENTS


NO. DATE ISSUE 02/03/2025 100% IFC 02/28/2025 ADDENDUM NO2

DATE: 02/28/2025 DRAWN: TELA

CHECKED: CTE TELA PROJECT NO: 22013.00

DRAWING TITLE: SOILS PLAN

L021

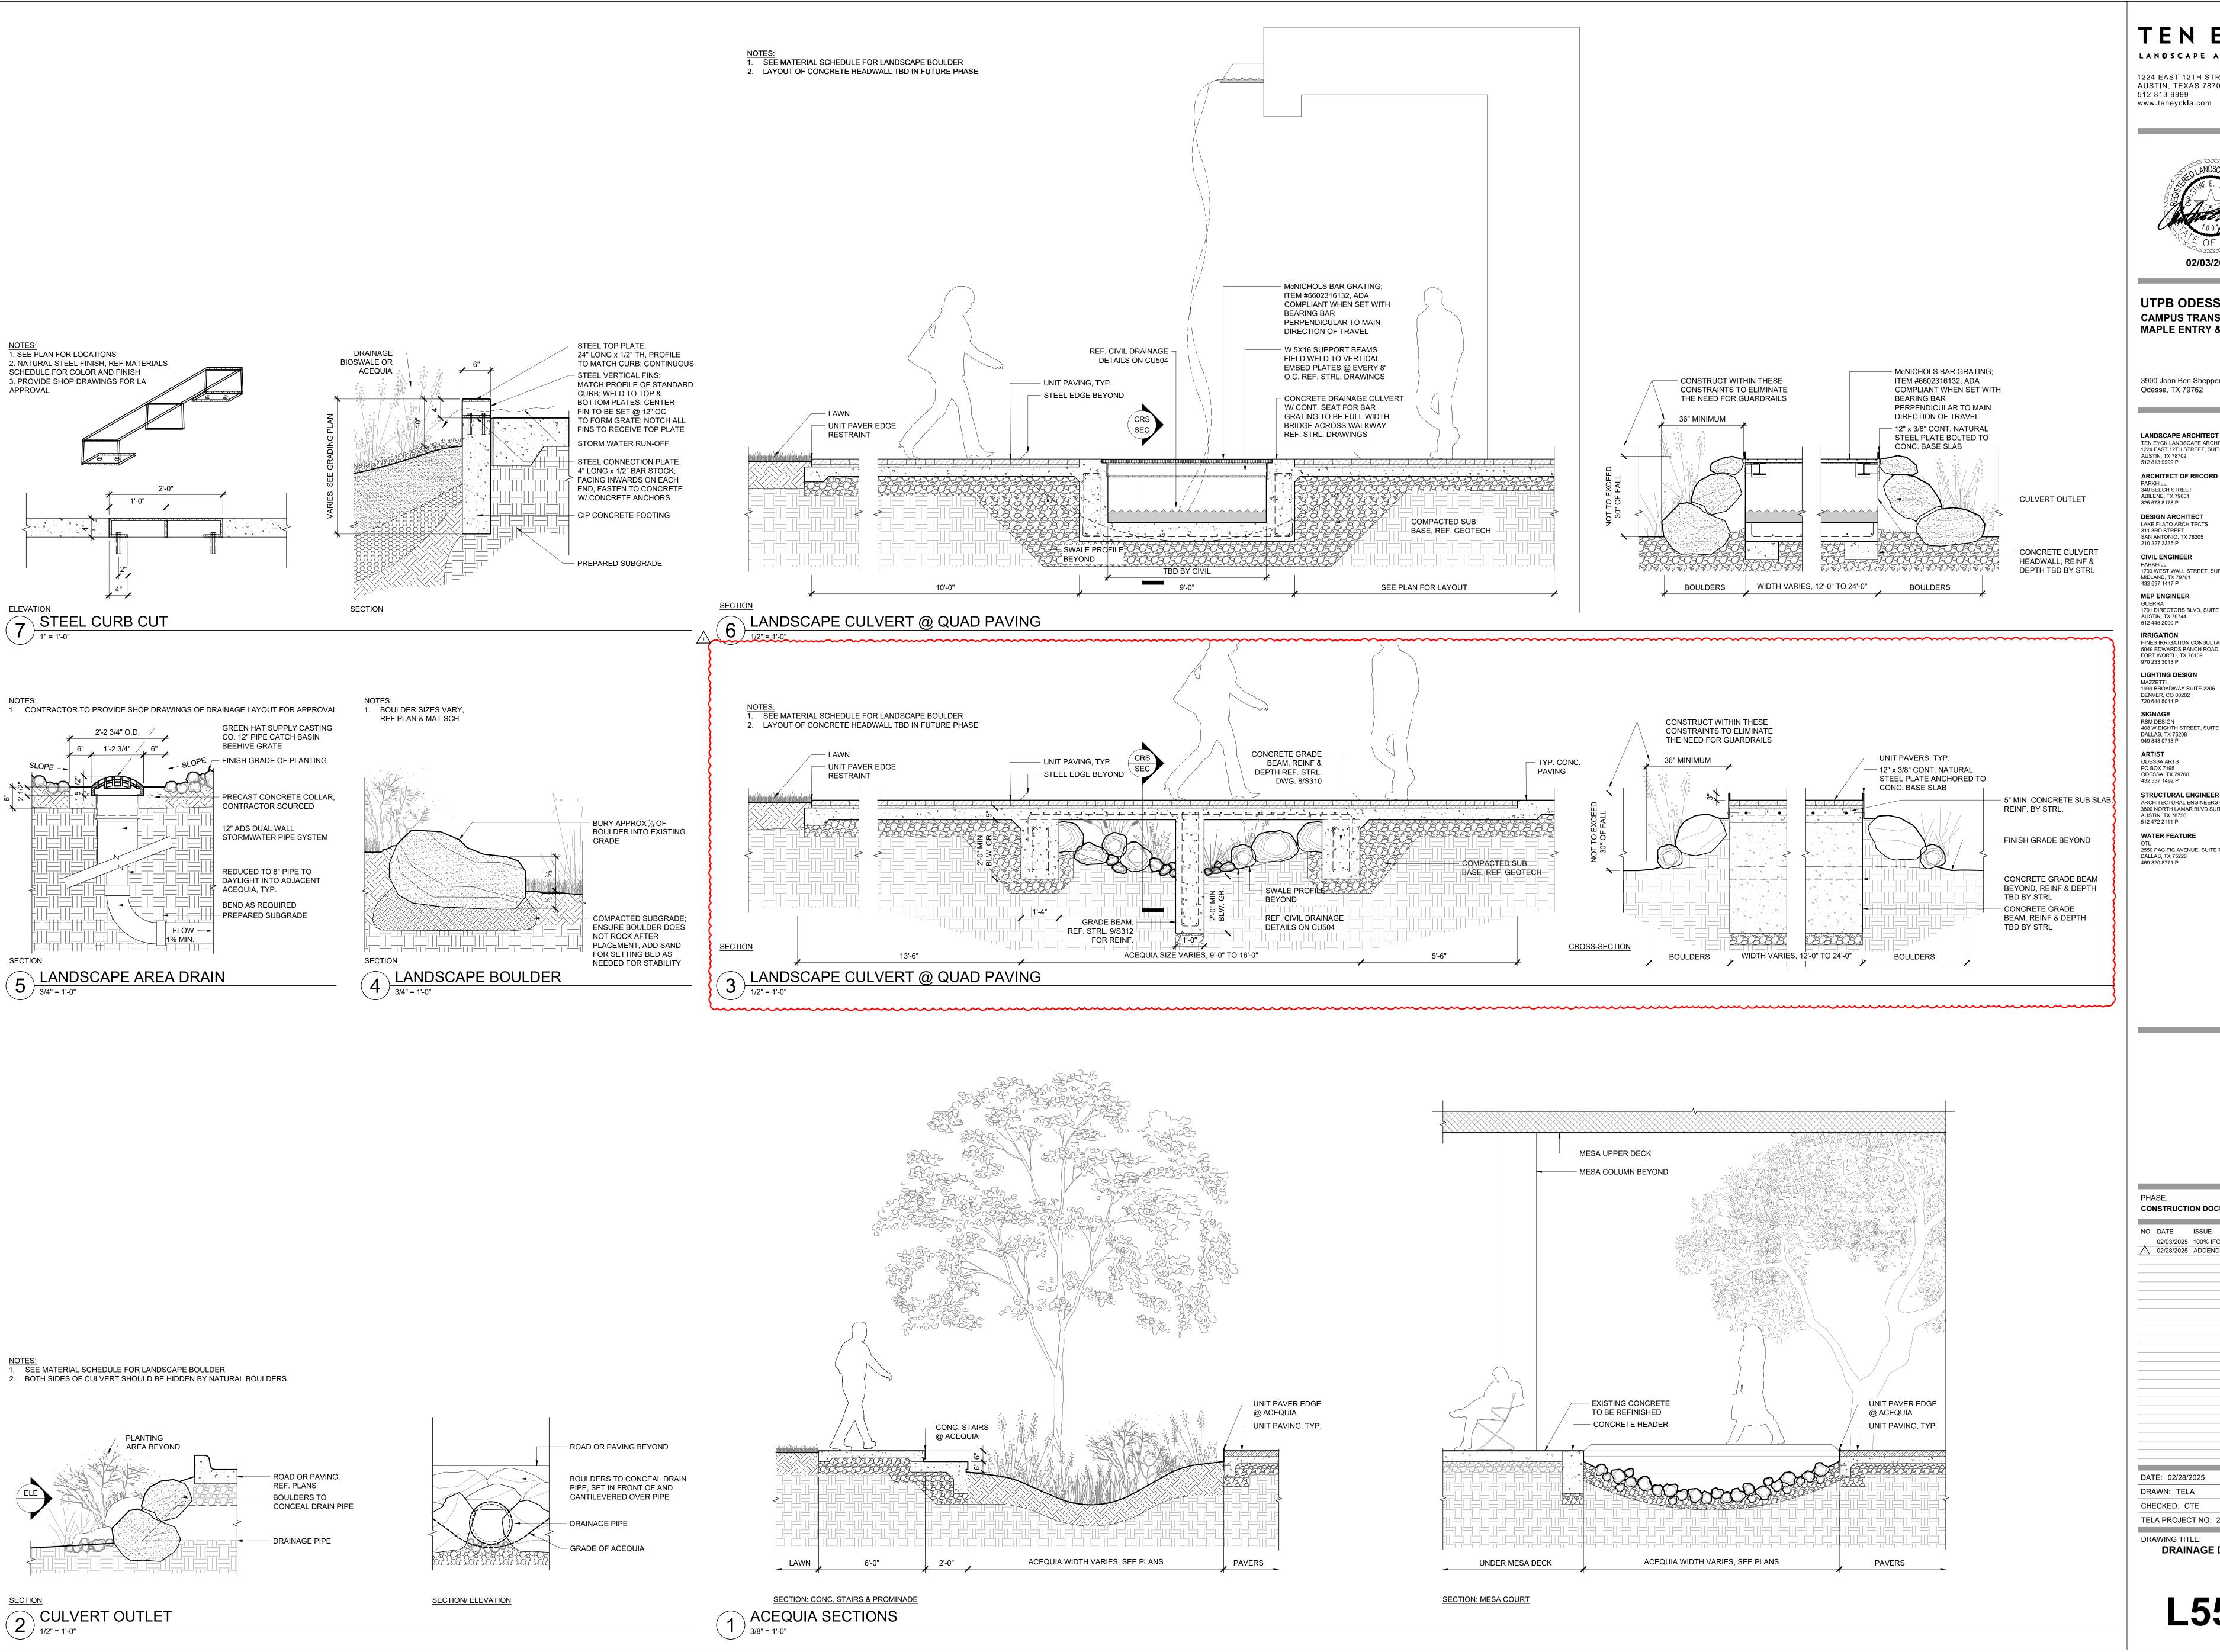

LANDSCAPE ARCHITECTS 1224 EAST 12TH STREET, SUITE 323 AUSTIN, TEXAS 78702



UTPB ODESSA CAMPUS TRANSFORMATION: MAPLE ENTRY & THE QUAD

3900 John Ben Shepperd Parkway Odessa, TX 79762

TEN EYCK LANDSCAPE ARCHITECTS, INC. 1224 EAST 12TH STREET, SUITE 323 AUSTIN, TX 78702 512 813 9999 P ARCHITECT OF RECORD

340 BEECH STREET ABILENE, TX 79601 325 673 8178 P **DESIGN ARCHITECT** LAKE FLATO ARCHITECTS

SAN ANTONIO, TX 78205 210 227 3335 P **CIVIL ENGINEER** 1700 WEST WALL STREET, SUITE 100

432 697 1447 P MEP ENGINEER 1701 DIRECTORS BLVD, SUITE 400

AUSTIN, TX 78744 512 445 2090 P IRRIGATION

HINES IRRIGATION CONSULTANTS 5049 EDWARDS RANCH ROAD, FLOOR 4 FORT WORTH, TX 76109

970 233 3013 P LIGHTING DESIGN

DENVER, CO 80202 720 644 5044 P SIGNAGE RSM DESIGN 408 W EIGHTH STREET, SUITE 201

DALLAS, TX 75208 ARTIST

> PO BOX 7195 ODESSA, TX 79760 432 337 1492 P

STRUCTURAL ENGINEER (LANDSCAPE) ARCHITECTURAL ENGINEERS COLLABORATIVE 3800 NORTH LAMAR BLVD SUITE 330 AUSTIN, TX 78756

WATER FEATURE

2550 PACIFIC AVENUE, SUITE 700 DALLAS, TX 75226 469 320 8771 P

CONSTRUCTION DOCUMENTS

NO. DATE ISSUE 02/03/2025 100% IFC 1 02/28/2025 ADDENDUM NO2


DATE: 02/28/2025

DRAWN: TELA CHECKED: CTE TELA PROJECT NO: 22013.00

DRAWING TITLE:

DRAINAGE DETAILS

L550

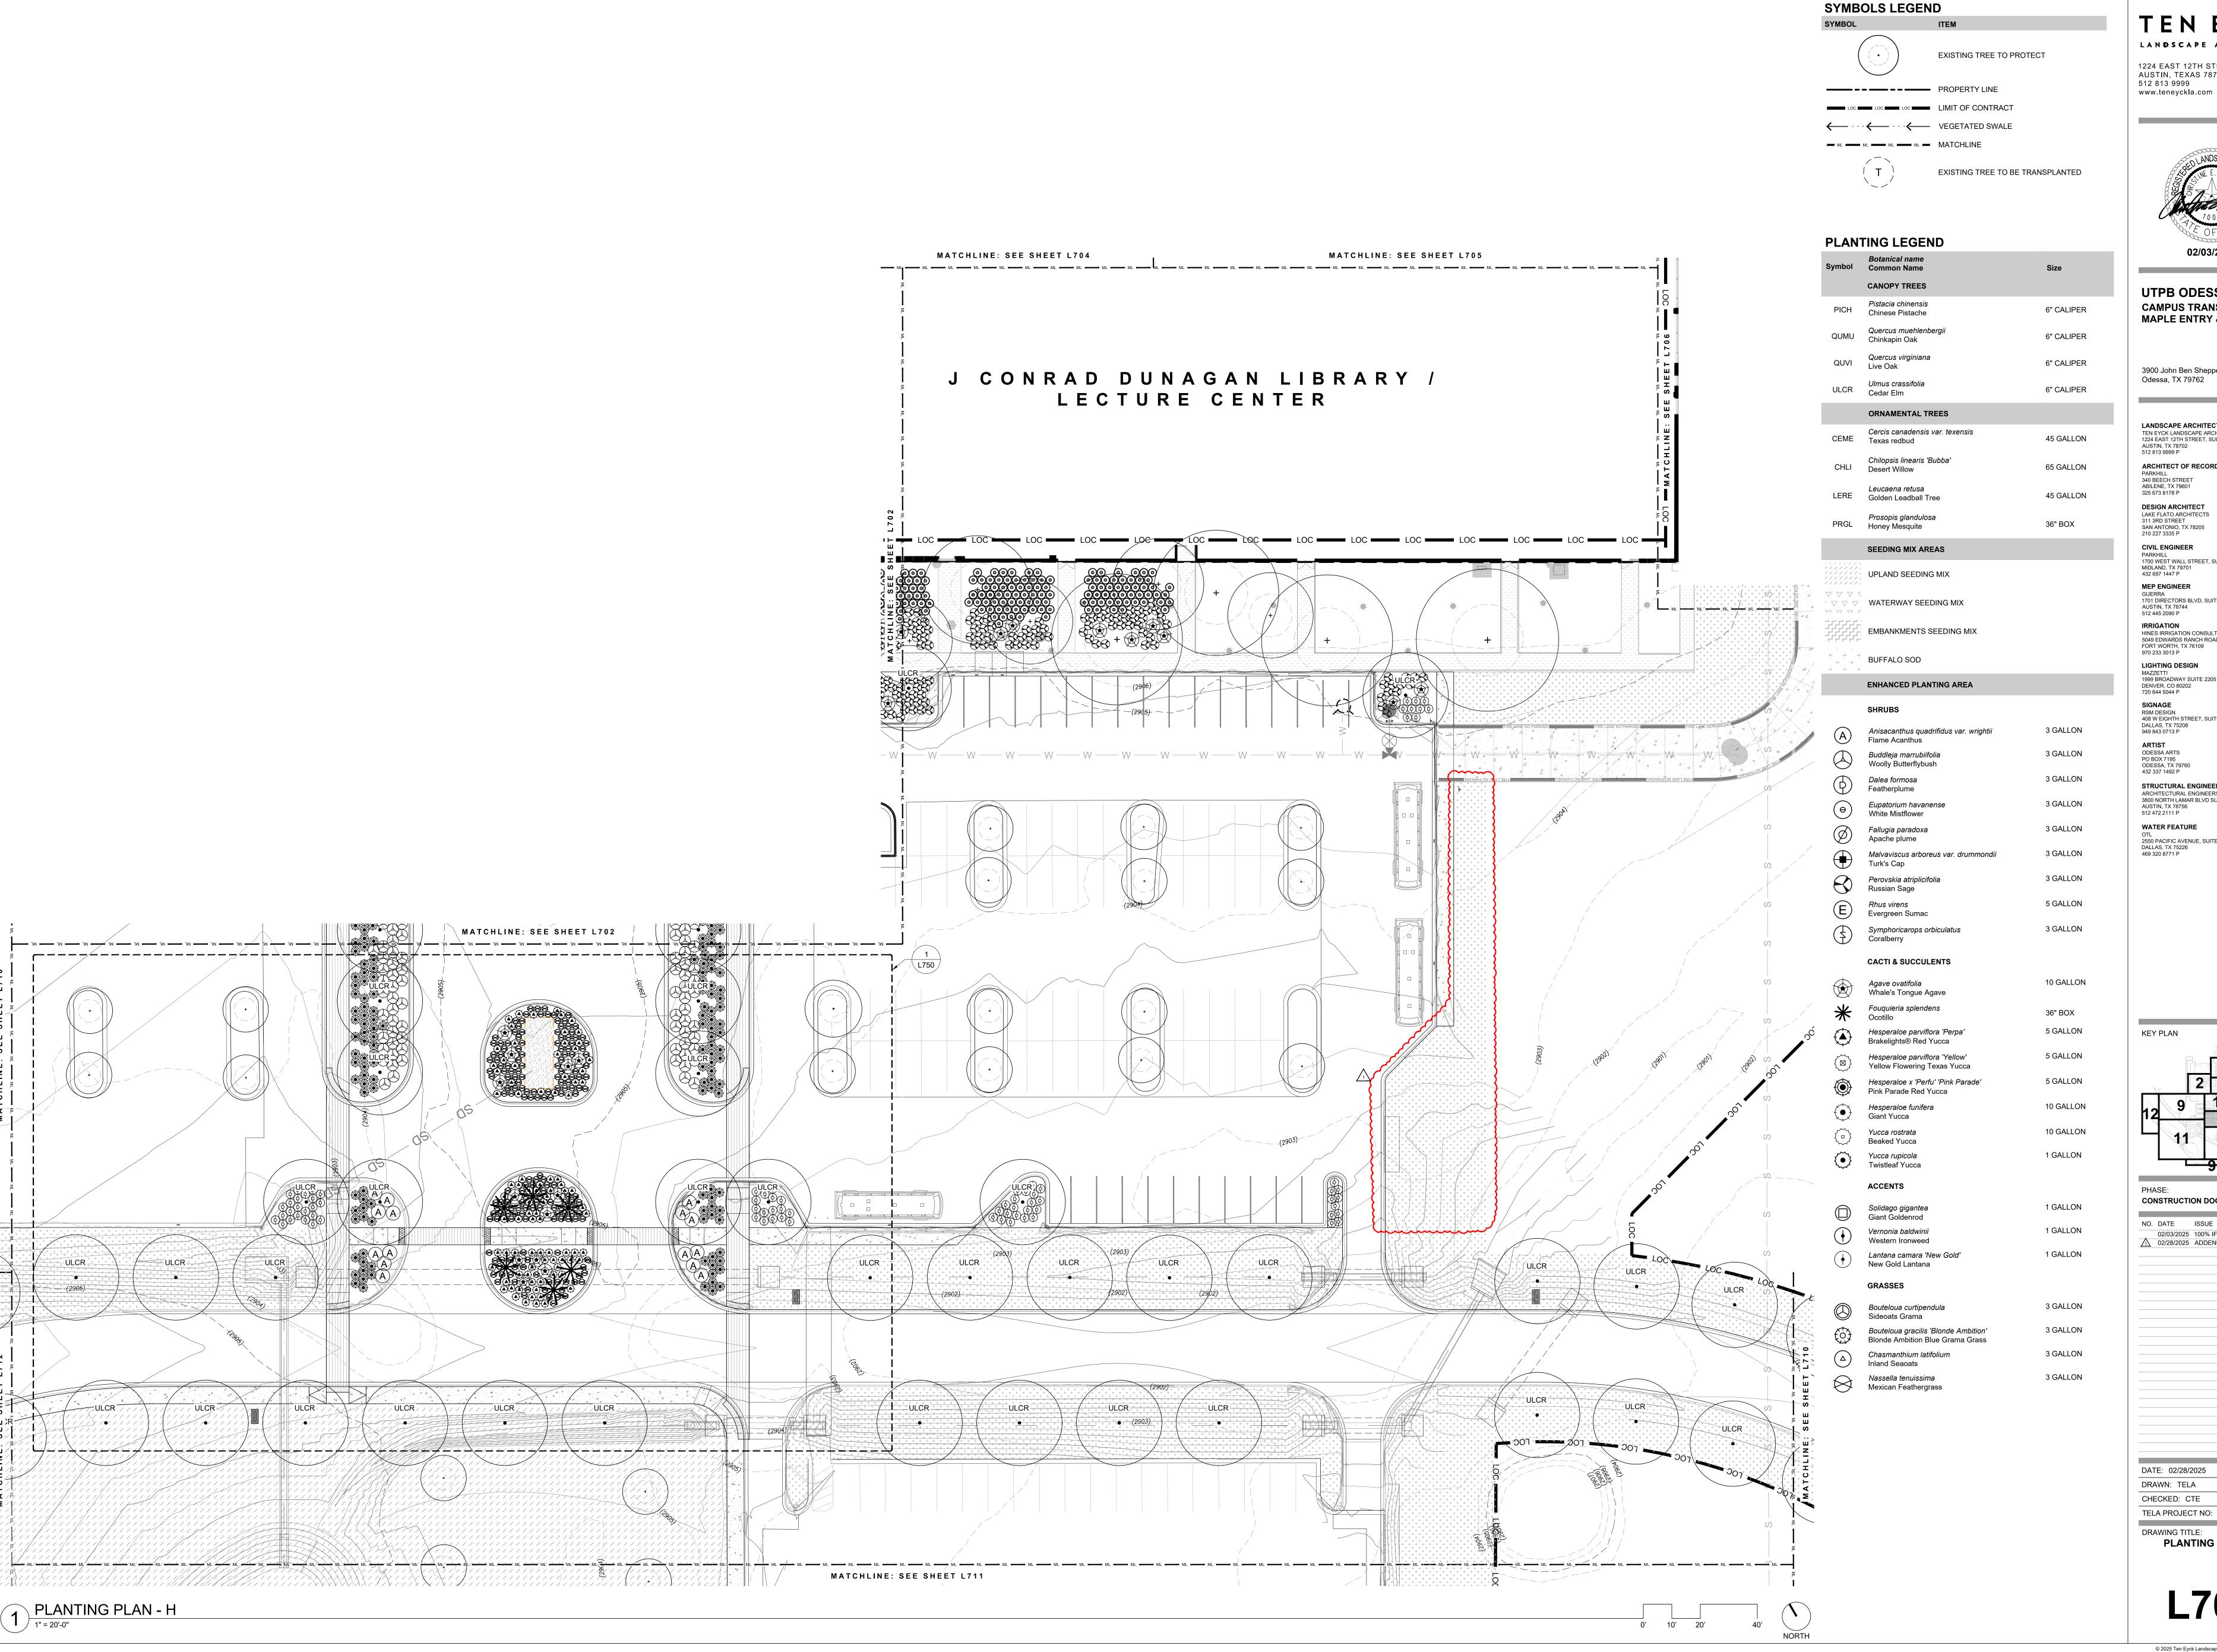

LANDSCAPE ARCHITECTS 1224 EAST 12TH STREET, SUITE 323 AUSTIN, TEXAS 78702



UTPB ODESSA CAMPUS TRANSFORMATION: MAPLE ENTRY & THE QUAD

3900 John Ben Shepperd Parkway Odessa, TX 79762

TEN EYCK LANDSCAPE ARCHITECTS, INC. 1224 EAST 12TH STREET, SUITE 323 AUSTIN, TX 78702 512 813 9999 P

340 BEECH STREET ABILENE, TX 79601 325 673 8178 P **DESIGN ARCHITECT** LAKE FLATO ARCHITECTS 311 3RD STREET

ARCHITECT OF RECORD

SAN ANTONIO, TX 78205 210 227 3335 P **CIVIL ENGINEER** 1700 WEST WALL STREET, SUITE 100

432 697 1447 P MEP ENGINEER 1701 DIRECTORS BLVD, SUITE 400 AUSTIN, TX 78744 512 445 2090 P


IRRIGATION HINES IRRIGATION CONSULTANTS 5049 EDWARDS RANCH ROAD, FLOOR 4 FORT WORTH, TX 76109

970 233 3013 P LIGHTING DESIGN 1999 BROADWAY SUITE 2205 DENVER, CO 80202 720 644 5044 P

SIGNAGE RSM DESIGN 408 W EIGHTH STREET, SUITE 201 DALLAS, TX 75208 949 843 0713 P ARTIST ODESSA ARTS PO BOX 7195 ODESSA, TX 79760 432 337 1492 P

STRUCTURAL ENGINEER (LANDSCAPE) 3800 NORTH LAMAR BLVD SUITE 330 AUSTIN, TX 78756 512 472 2111 P

WATER FEATURE 2550 PACIFIC AVENUE, SUITE 700 DALLAS, TX 75226 469 320 8771 P

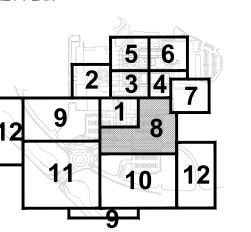


CONSTRUCTION DOCUMENTS

NO. DATE ISSUE 02/03/2025 100% IFC 02/28/2025 ADDENDUM NO2


DATE: 02/28/2025 DRAWN: TELA

CHECKED: CTE TELA PROJECT NO: 22013.00

DRAWING TITLE: PLANTING PLAN - H

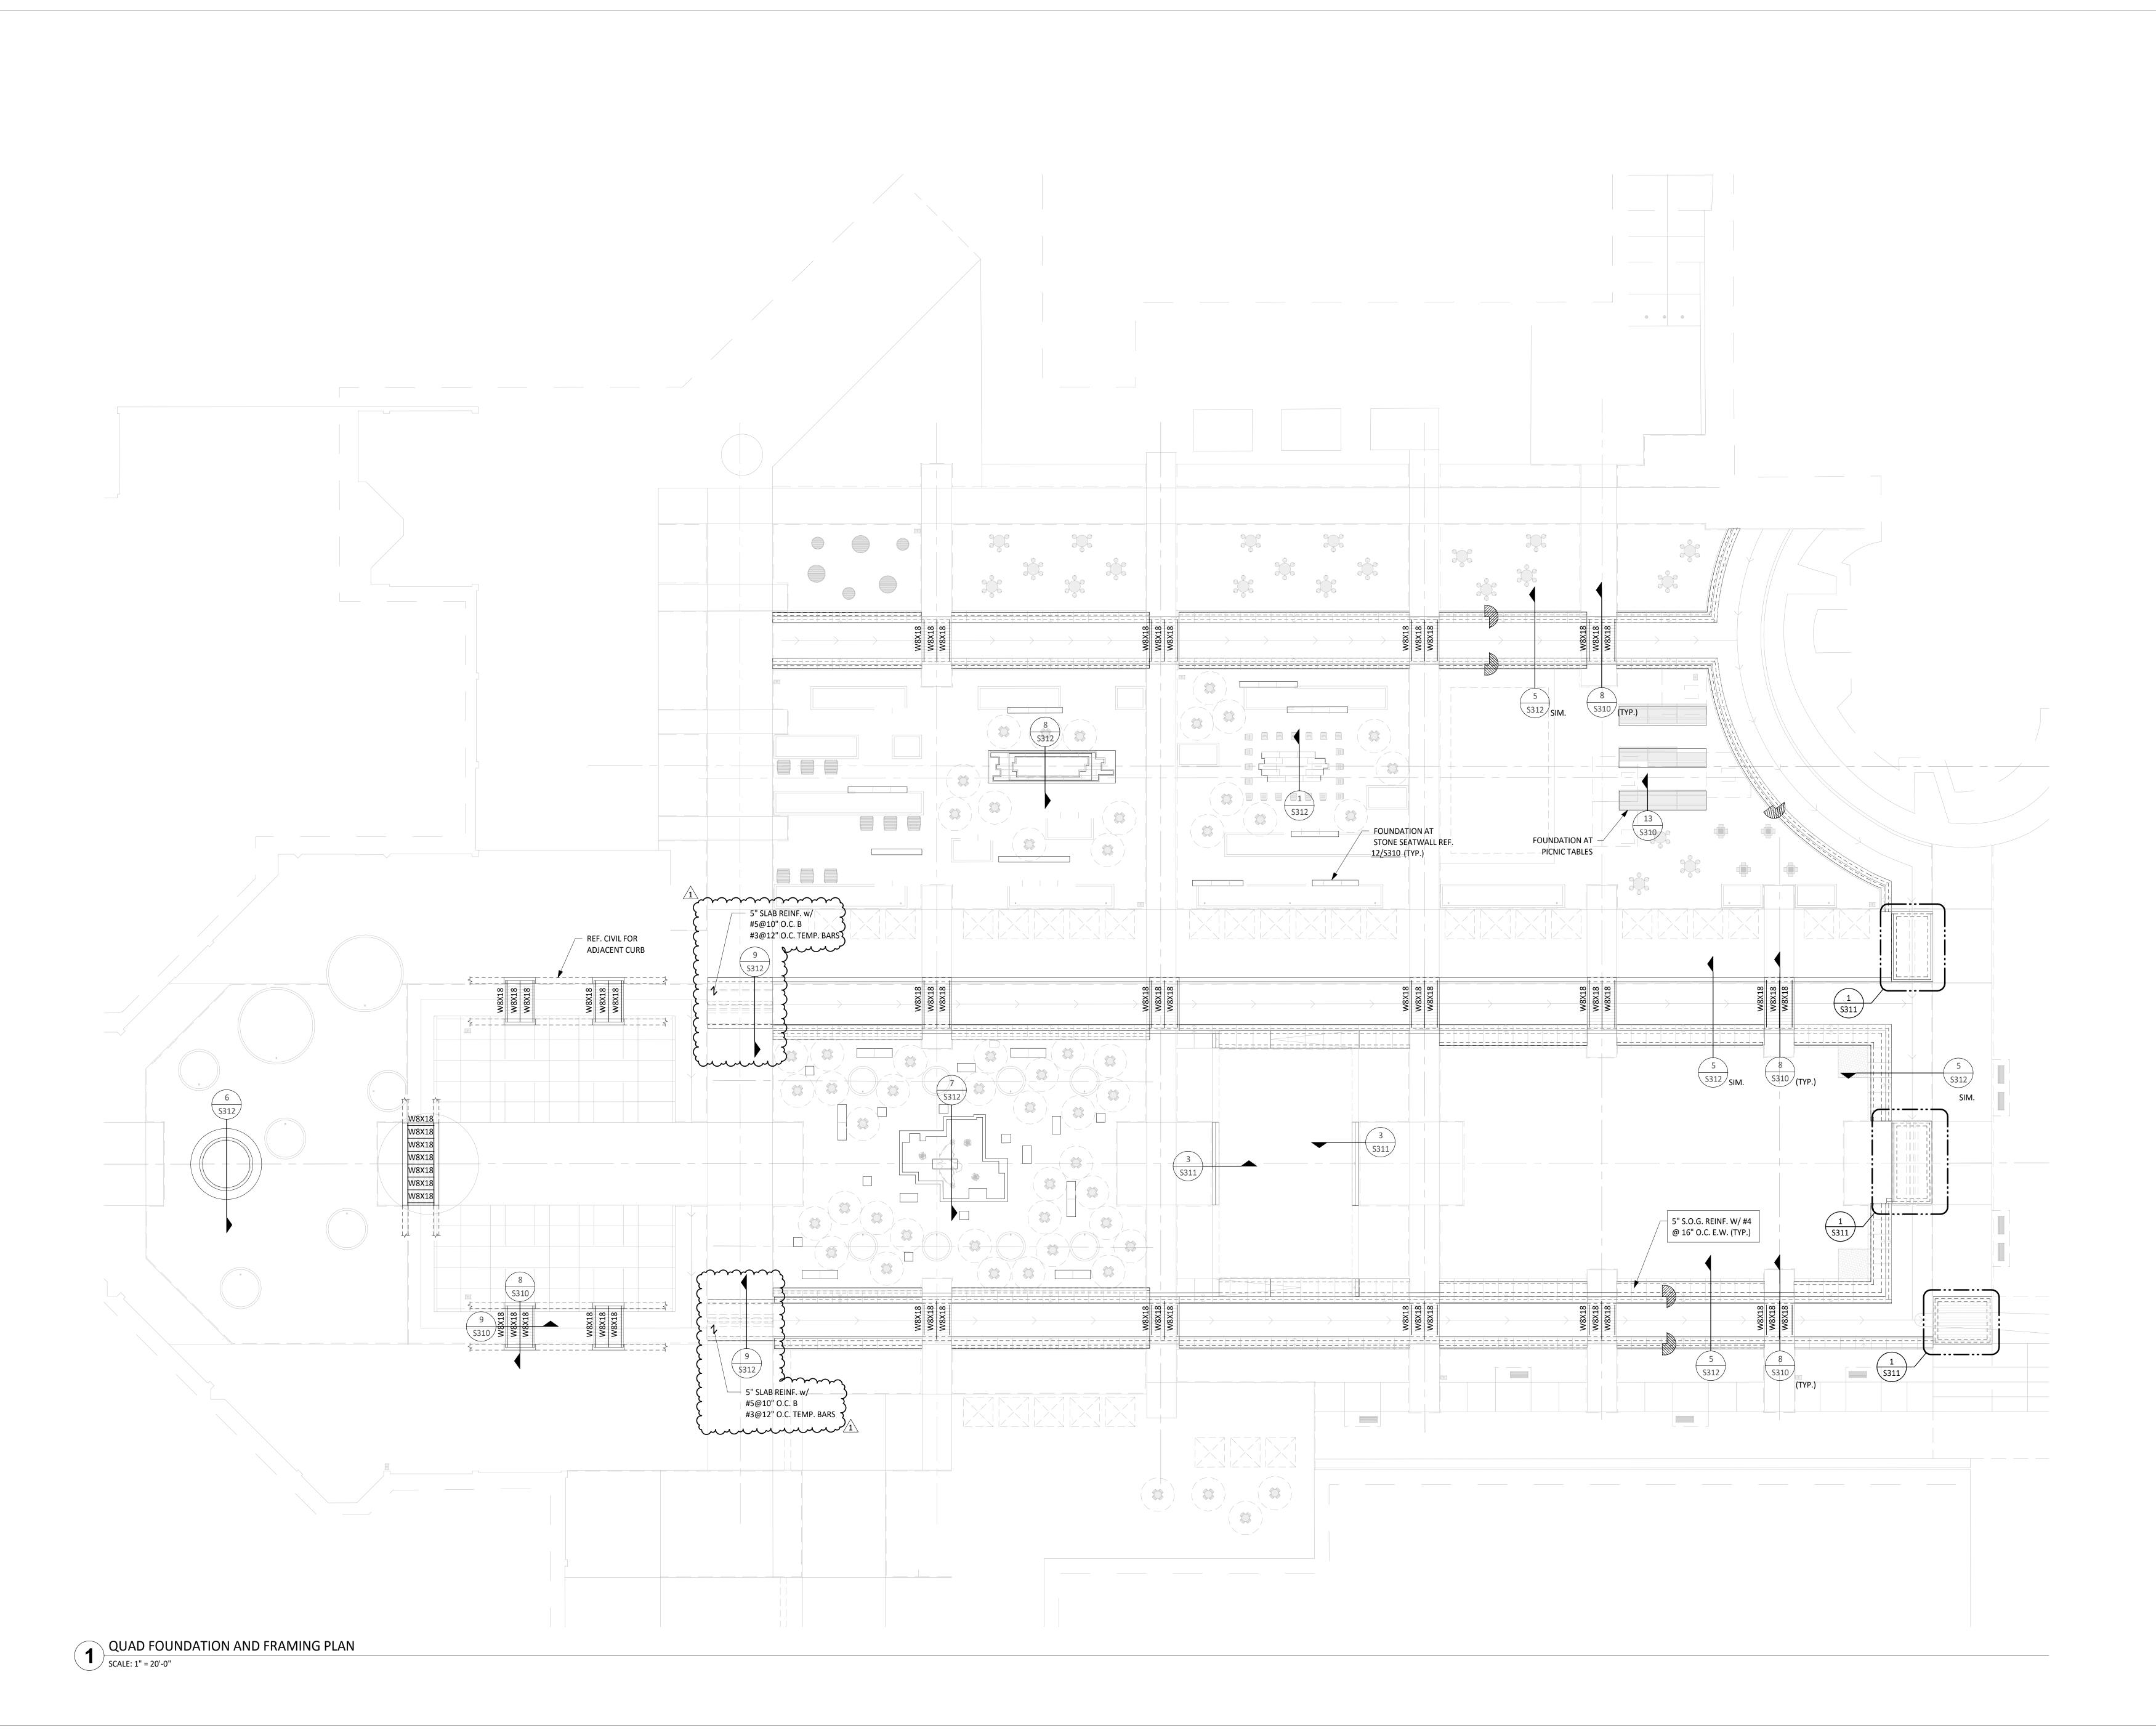

1224 EAST 12TH STREET, SUITE 323 AUSTIN, TEXAS 78702 512 813 9999 P www.teneyckla.com

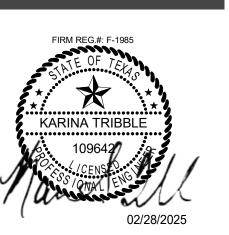

UTPB ODESSA

CAMPUS TRANSFORMATION:
MAPLE ENTRY & THE QUAD

3900 John Ben Shepperd Pkwy, Odessa, TX 79762

LANDSCAPE ARCHITECT
TEN EYCK LANDSCAPE ARCHITECTS, INC.
1224 EAST 12TH STREET, SUITE 323
AUSTIN, TX 78702
512 813 9999 P

512 813 9999 P

ARCHITECT OF RECORD
PARKHILL
340 BEECH STREET
ABILENE, TX 79601
325 673 8178 P

DESIGN ARCHITECT
LAKE FLATO ARCHITECTS
311 3RD STREET
SAN ANTONIO, TX 78205
210 227 3335 P

CIVIL ENGINEER

PARKHILL

1700 WEST WALL STREET, SUITE 100

MIDLAND, TX 79701

432 697 1447 P

MEP ENGINEER
GUERRA
1701 DIRECTORS BLVD SUITE 4

GUERRA
1701 DIRECTORS BLVD SUITE 400
AUSTIN, TX 78744
512 445 2090 P

IRRIGATION

HINES IRRIGATION CONSULTANTS
5049 EDWARDS RANCH ROAD, FLOOR 4
FORT WORTH, TX 76109
970 233 3013 P

LIGHTING DESIGN

MAZZETTI
1999 BROADWAY SUITE 2205
DENVER, CO 80202
720 644 5044 P

SIGNAGE
RSM DESIGN
4100 COMMERCE STREET #7
DALLAS, TX 75226
949 843 0713 P

ARTIST

ODESSA ARTS
PO BOX 7195


ODESSA, TX 79760
432 337 1492 P

COST ESTIMATOR
VERMEULENS
325 NORTH ST. PAUL STREET, SUITE 3100
DALLAS, TX 75201
469 965 1333 P

WATER FEATURE
OTL
2550 PACIFIC AVENUE, SUITE 700
DALLAS, TX 75226
469 320 8771 P



KEY DI AN

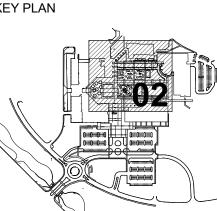

CONSTRUCTION DOCUMENTS

NO. DATE ISSUE

02/03/2025 100% CD

1 02/28/2025 ADDENDUM NO2

DATE: 02.03.2025

DRAWN: AS, LM


CHECKED: KT

DRAWN: AS, LM
CHECKED: KT
TELA PROJECT NO: 22013.00


DRAWING TITLE:

QUAD FOUNDATION
AND FRAMING PLAN

S202

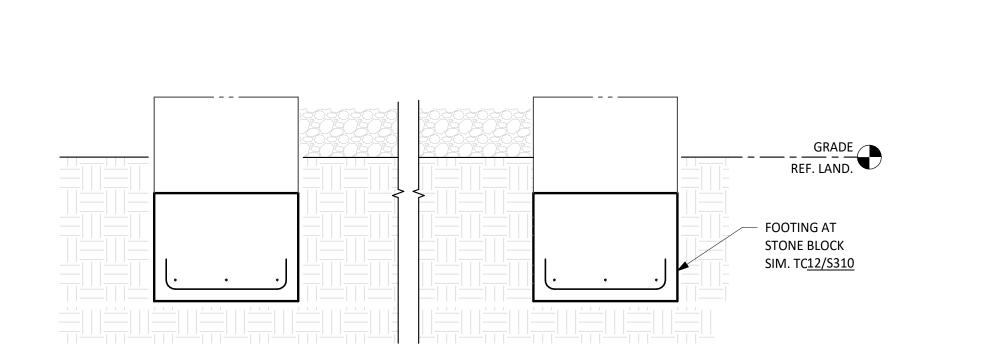




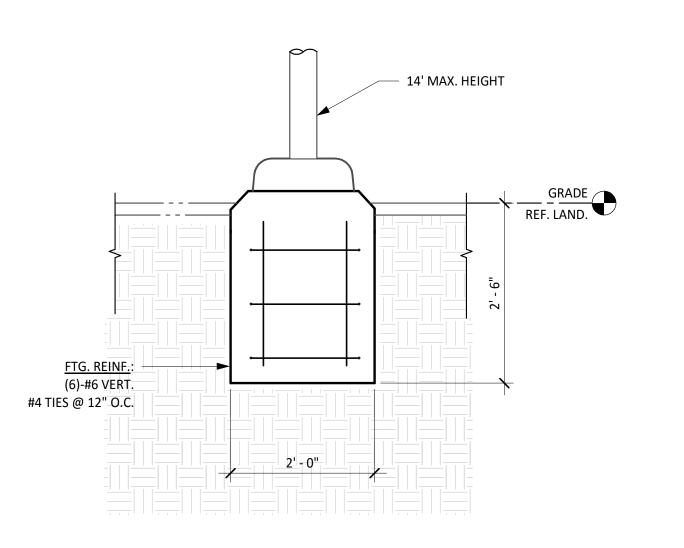


FOUNDATION AT LIGHT POSTS - E3, E24


SCALE: 3/4" = 1'-0"

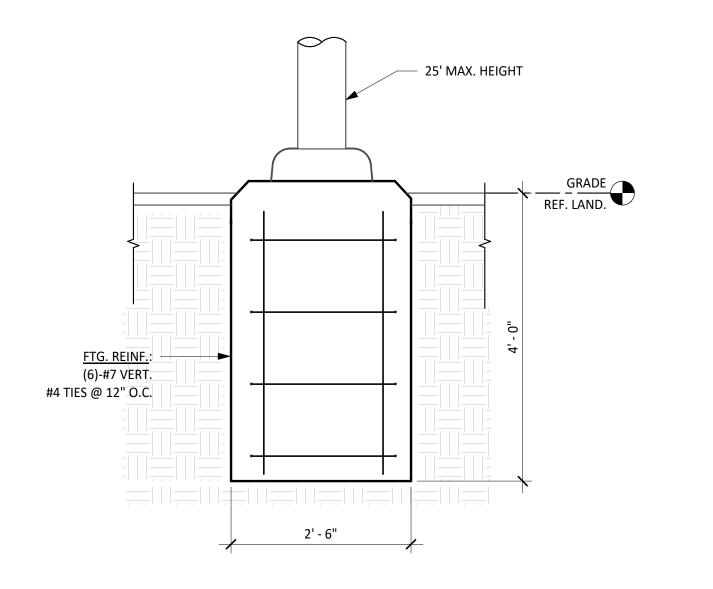

FOUNDATION AT LIGHT POSTS - E1, E2, E19, E21 SCALE: 3/4" = 1'-0"

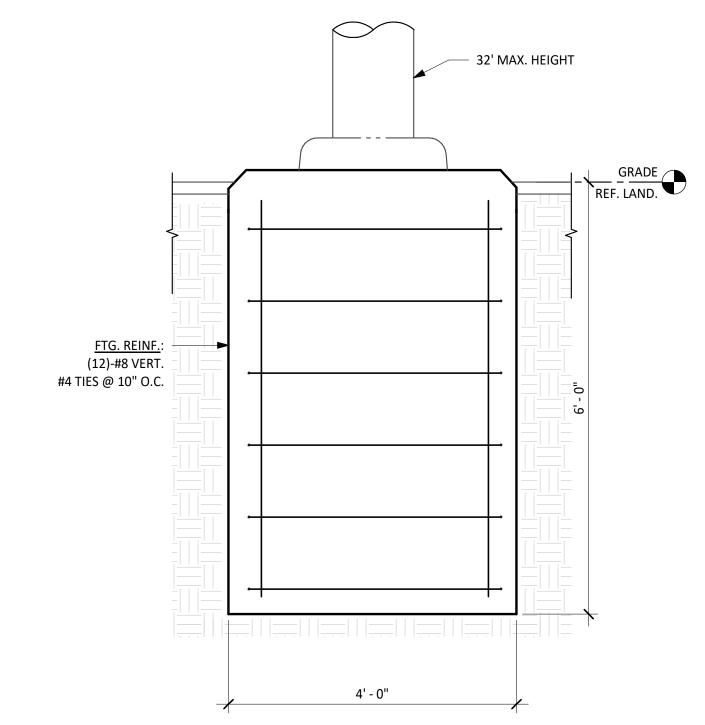

FOUNDATION AT LIGHT POSTS - E15

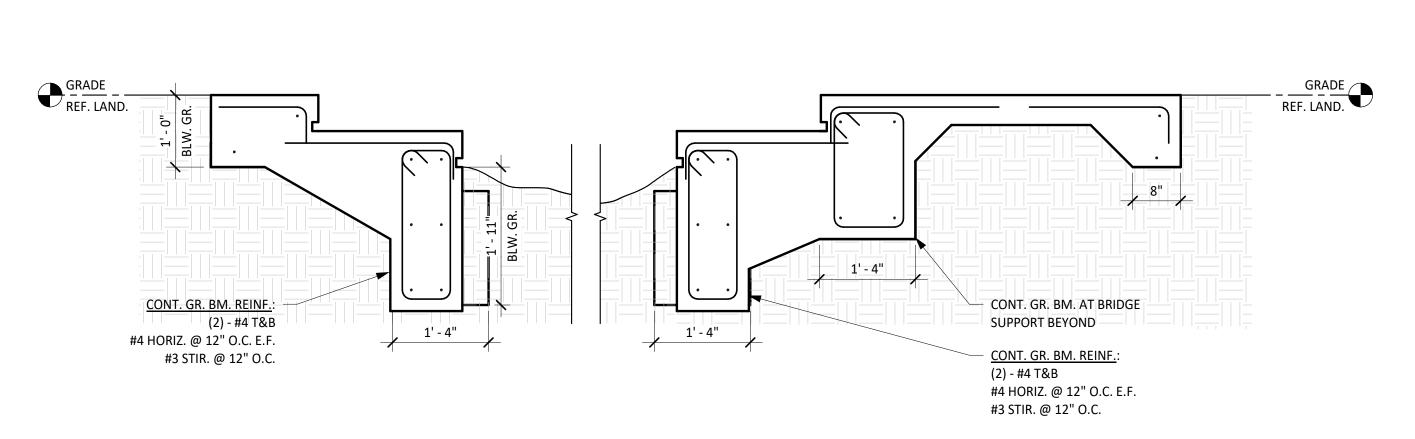



SECTION - ACEQUIA


SCALE: 3/4" = 1'-0"


7 FOUNDATION AT FIONA FOUNTAIN

SCALE: 3/8" = 1'-0"

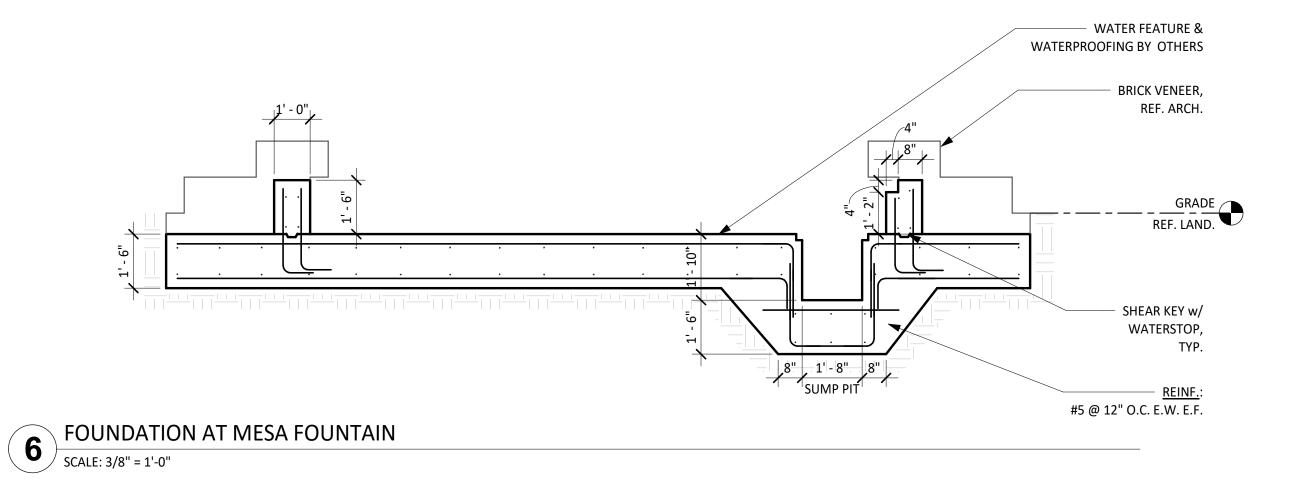


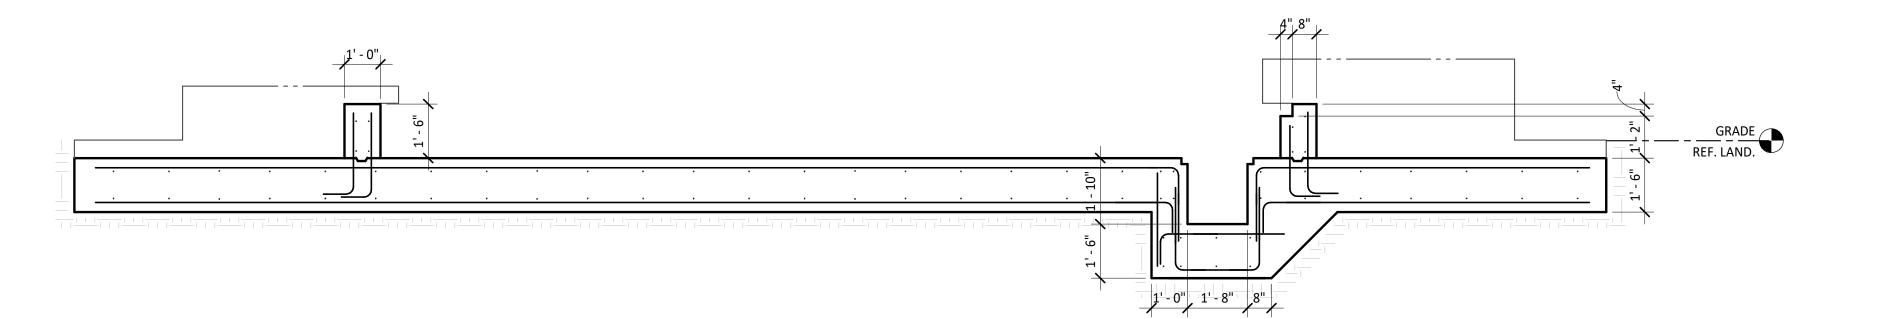

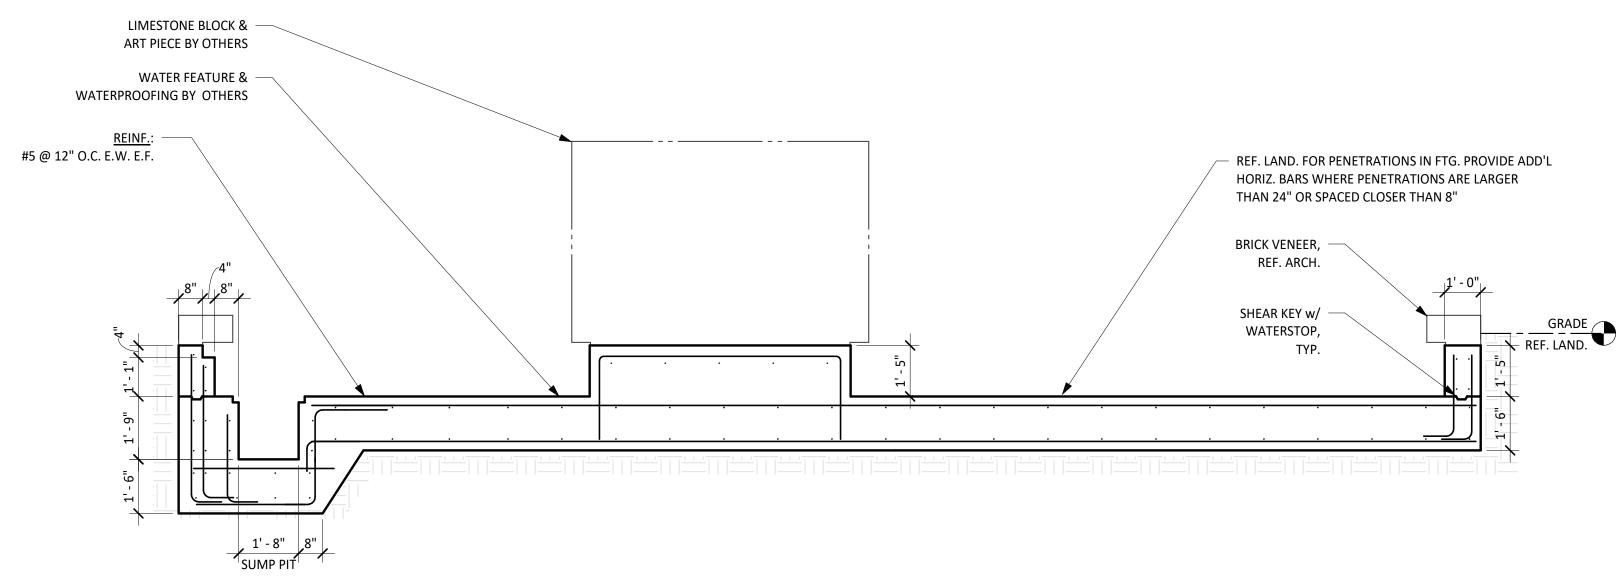

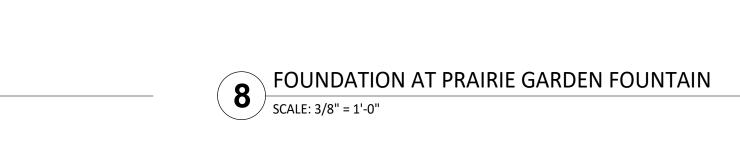

8" 1'-4" 8" SUMP PIT

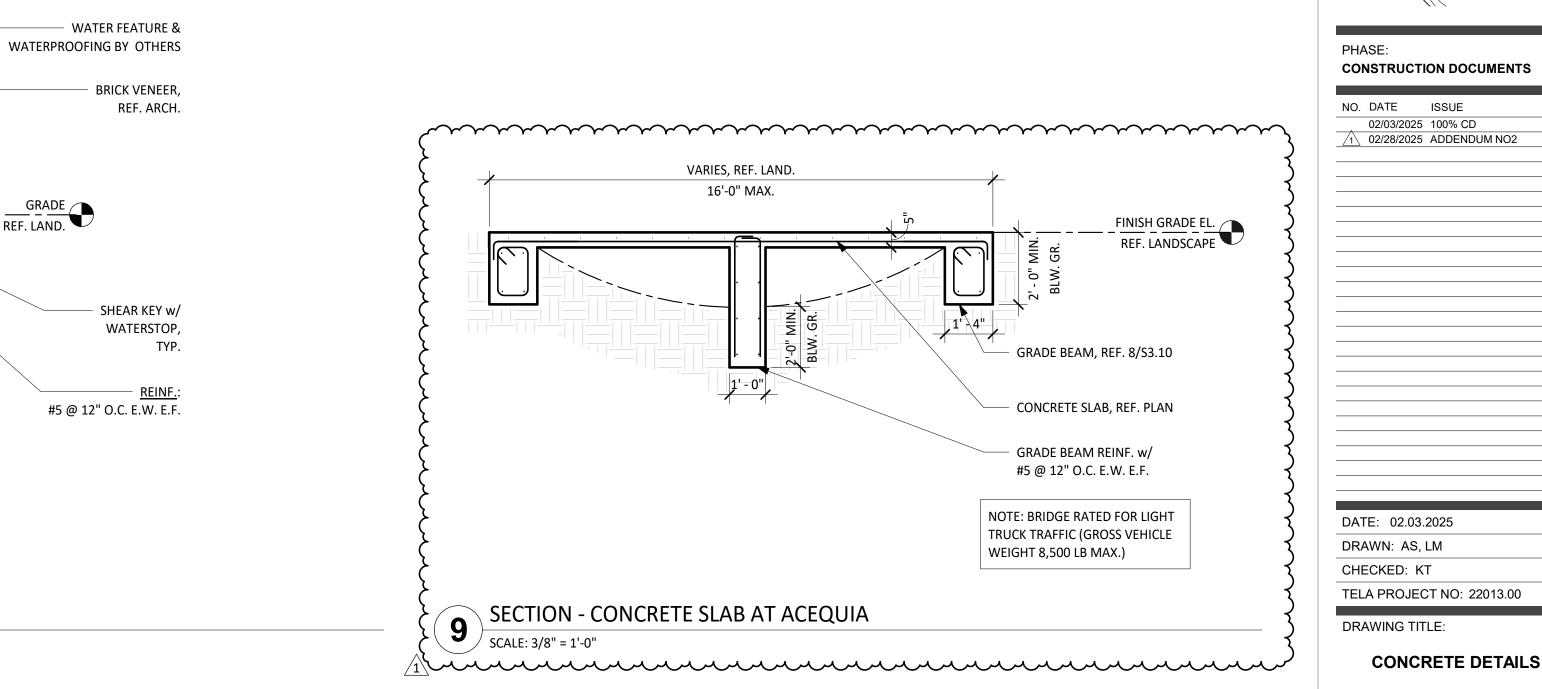

TEN EYCK LANDSCAPE ARCHITECTS

> 1224 EAST 12TH STREET, SUITE 323 AUSTIN, TEXAS 78702 512 813 9999 P www.teneyckla.com



UTPB ODESSA CAMPUS TRANSFORMATION: MAPLE ENTRY & THE QUAD

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LANDSCAPE ARCHITECT

TEN EYCK LANDSCAPE ARCHITECTS, INC. 1224 EAST 12TH STREET, SUITE 323 AUSTIN, TX 78702 512 813 9999 P ARCHITECT OF RECORD

PARKHILL 340 BEECH STREET ABILENE, TX 79601 325 673 8178 P **DESIGN ARCHITECT** LAKE FLATO ARCHITECTS
311 3RD STREET
SAN ANTONIO, TX 78205
210 227 3335 P

CIVIL ENGINEER PARKHILL 1700 WEST WALL STREET, SUITE 100 MIDLAND, TX 79701 432 697 1447 P

MEP ENGINEER

GUERRA 1701 DIRECTORS BLVD SUITE 400 AUSTIN, TX 78744 512 445 2090 P IRRIGATION

HINES IRRIGATION CONSULTANTS 5049 EDWARDS RANCH ROAD, FLOOR 4 FORT WORTH, TX 76109 970 233 3013 P

MAZZETTI 1999 BROADWAY SUITE 2205 DENVER, CO 80202 720 644 5044 P

SIGNAGE RSM DESIGN 4100 COMMERCE STREET #7 DALLAS, TX 75226 949 843 0713 P


LIGHTING DESIGN

ARTIST
ODESSA ARTS
PO BOX 7195
ODESSA, TX 79760
432 337 1492 P COST ESTIMATOR

VERMEULENS 325 NORTH ST. PAUL STREET, SUITE 3100 DALLAS, TX 75201 469 965 1333 P

WATER FEATURE OTL 2550 PACIFIC AVENUE, SUITE 700 DALLAS, TX 75226 469 320 8771 P

A TYLin Company

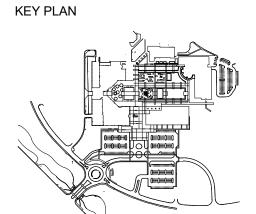

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DATE: 02.03.2025 DRAWN: AS, LM CHECKED: KT TELA PROJECT NO: 22013.00

DRAWING TITLE: **CONCRETE DETAILS**

S312